
WYE RIVER AND SEPARATION CREEK STORMWATER MANAGEMENT SYSTEM - PITS AND PIPES

FOR COLAC OTWAY SHIRE

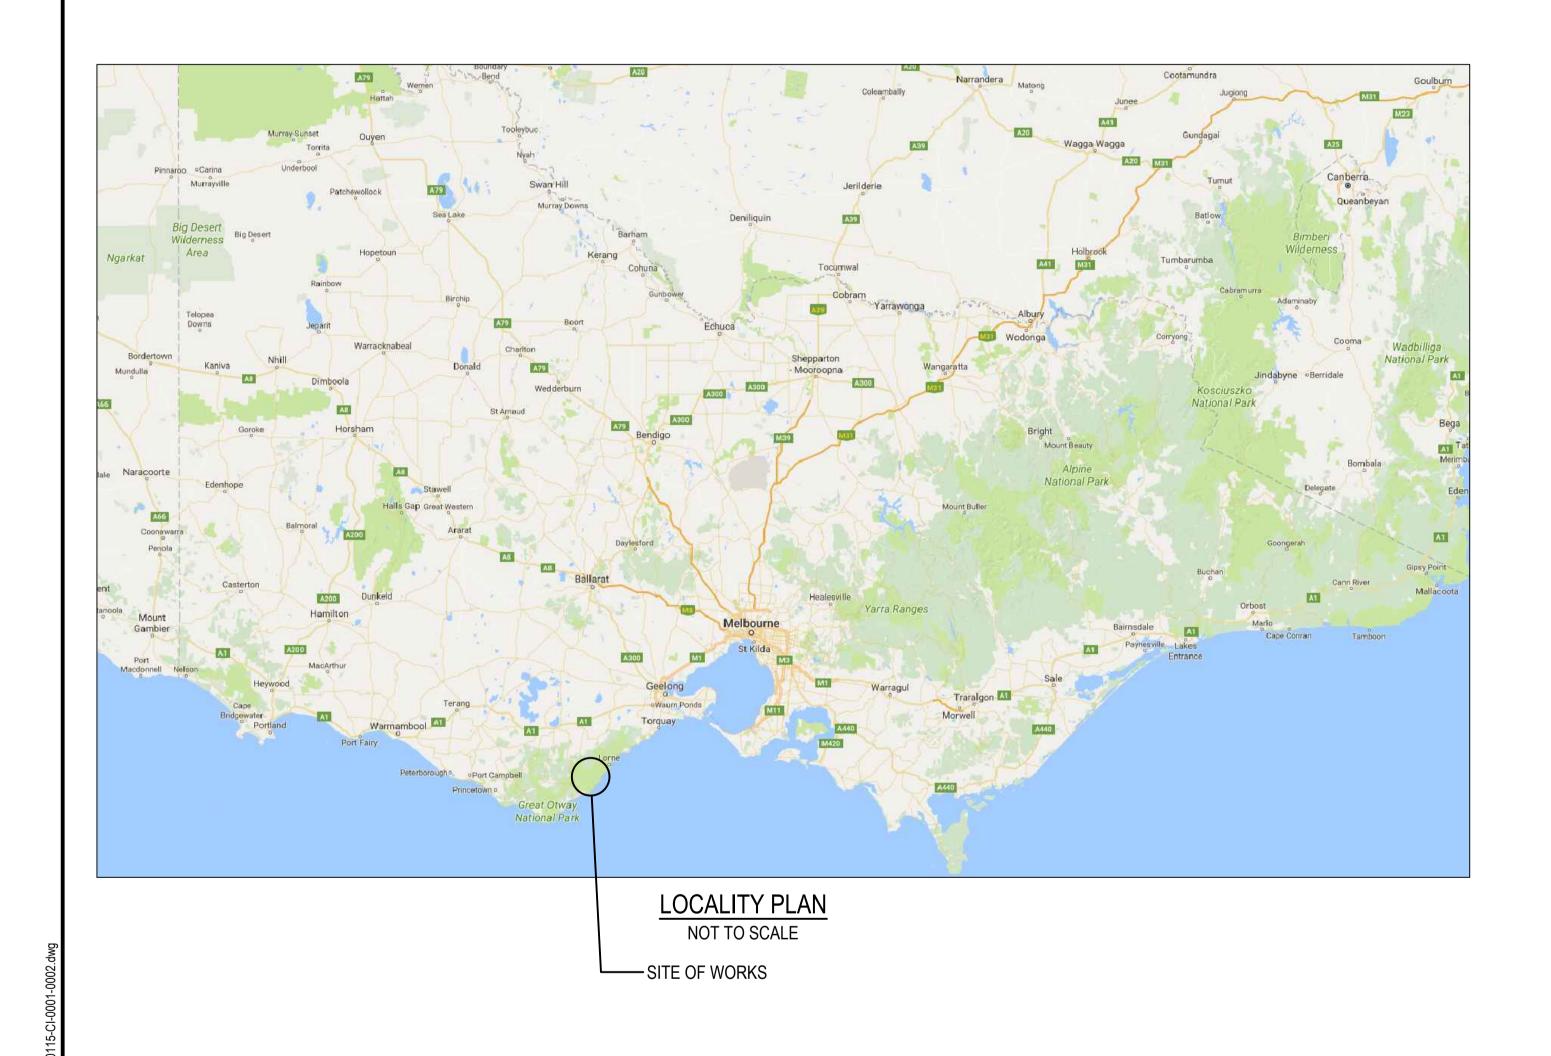



WARNING

EXTERNAL APPROVAL

THIS DRAWING IS SUBJECT TO THE APPROVAL OF

COLAC OTWAY SHIRE

AND IS A PRELIMINARY ISSUE

V170115-CI-0001

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awn .O	Date 18/10/2017	COLAC OTWAY SHIRE
ecked E.H	Date 18/10/2017	Project WYE RIVER AND SEPARATION C
signed E.H	Date 18/10/2017	MANAGEMENT SYSTEM
rified	Date	DETAILED DESIGN PITS AND PIP
proved	Date	LOCALITY PLAN

OLAC OTWAT SHINL				
YE RIVER AND SEPARATION CREEK STORMWATER	Status	FOR TENI	DER ONL'	Y
ANAGEMENT SYSTEM	NOT TO BE	USED FOR CO	NSTRUCTION	N PURPOS
ETAILED DESIGN PITS AND PIPES	Datum	Melways Ref.	Scale	Size
OCALITY PLAN	A.H.D	X927,C9	NTS	A1
	Drawing Number			Dovisi

Date

WYE RIVER AND SEPARATION CREEK STORMWATER MANAGEMENT SYSTEM - PITS AND PIPES

COLAC OTWAY SHIRE

1. GENERAL **ELECTRONIC PLANS**

ELECTRONIC PLANS MAY BE PROVIDED TO ASSIST THE CONTRACTOR BUT DO NOT FORM PART OF THE CONTRACT. IN THE CASE OF DISCREPANCY BETWEEN THE ELECTRONIC INFORMATION AND THE HARD COPY PLANS THE HARD COPY PLANS TAKE PRECEDENT.

SURVEY SURVEY DATUM

THESE PLANS ARE BASED UPON THE EXISTING CONDITIONS SURVEY PREPARED BY TGM GROUP PTY LTD. LEVELS SHOWN ARE TO

SET OUT

THAT THE PROPOSED VERTICAL AND HORIZONTAL ALIGNMENT ARE CONSISTENT WITH THE INFORMATION SHOWN ON THE

AS-CONSTRUCTED SURVEY

DRAWINGS. ANY DISCREPANCY SHALL BE REFERRED TO CARDNO PRIOR TO CONSTRUCTION. REFERENCES PROTECTION

OTWAY SHIRE REQUIREMENTS.

EROSION AND SEDIMENT CONTROL PLAN.

ALL DIMENSIONS ARE TO INVERT OF KERB OR OUTER EDGE OF LINEMARKING WHERE APPLICABLE THE CONTRACTOR SHALL MAINTAIN AND PROTECT THE PEGS AND SURVEY MARKS FOR THE DURATION OF THE WORKS. UPON COMPLETION OF THE CIVIL WORKS THE CONTRACTOR SHALL PROVIDE CERTIFIED AS-CONSTRUCTED PLANS OF THE WORKS AND AN AS-CONSTRUCTED SURVEY OF ALL COLAC OTWAY SHIRE DRAINAGE WORKS IN D SPEC FORMAT OR EQUIVALENT TO COLAC

EARTHWORKS SHALL BE CARRIED OUT TO THE FINISHED SURFACE LEVELS SHOWN ON THE PLANS AND CROSS SECTIONS. CUT

BATTERS SHALL NOT EXCEED 1 IN 5 AND FILL BATTERS SHALL NOT EXCEED 1 IN 6 SLOPE UNLESS INDICATED OTHERWISE IN

REFER TO THE GEOTECHNICAL REPORT 31/34316 PREPARED BY GHD FOR SITE RECOMMENDATIONS AND SOIL CONDITIONS.

THE CONTRACTOR SHALL STRIP ALL AREAS SUBJECT TO BULK EARTHWORKS, PAVEMENT CONSTRUCTION OR BUILDING WORKS OF

3. EARTHWORKS GENERAL

DIMENSIONS

GEOTECHNICAL DATA

COMPACTION TO AS1289

FILLING

THE CONTRACTOR SHALL OBTAIN 98% STANDARD MINIMUM DRY DENSITY COMPACTION ON ALL FINISHED SUBGRADES AND FORMATIONS. ACCORDANCE WITH THE SPECIFICATIONS AND AS3798. APPROVED MATERIAL WON FROM SITE OR APPROVED IMPORTED FILL SHALL BE MOISTURE CONDITIONED IN ACCORDANCE WITH THE RECOMMENDATIONS OF THE GEOTECHNICAL REPORT PRIOR TO BEING PLACED IN UNIFORM HORIZONTAL LAYERS OF 200mm MAXIMUM DEPTH AND COMPACTED AS SPECIFIED. ALL FINISHED SURFACES SHALL ACHIEVE A MINIMUM COMPACTION OF 98% STANDARD DRY DENSITY. COMPACTION TESTING OF ALL FILL SHALL BE CARRIED

ALL TOPSOIL AND OTHER DELETERIOUS MATERIAL FOR REUSE ON TOP OF TRENCH BACKFILL.

OUT IN ACCORDANCE WITH THE REQUIREMENTS OF AS 3798.

REINSTATEMENT

THE CONTRACTOR SHALL REGRADE, SHAPE, TOPSOIL AND GRASS ALL ADJACENT EXISTING GRASSED AREAS THAT ARE DISTURBED OR ALTERED AS A CONSEQUENCE OF THE PROPOSED WORKS.

4. LANDSCAPING ALL EXISTING TREES IN THE VICINITY OF THE WORKS AREAS THAT ARE TO BE RETAINED SHALL BE PRUNED, ROOTS CUT & SEALED EXISTING WHERE THEY EXTEND BENEATH NEW WORKS, BY APPROPRIATELY QUALIFIED PERSONNEL. TREES TO BE REMOVED SHALL HAVE

ALL ROOTS GRUBBED OUT AND BE MADE GOOD WITH COMPACTED FILL 5. SITE CLEARANCE

DEMOLITION ALL EXISTING REDUNDANT CONCRETE, PAVEMENT, SOIL, RUBBISH AND CONSTRUCTION DEBRIS SHALL BE TAKEN UP AND REMOVED

PRIOR TO COMPLETION, THE CONTRACTOR SHALL ENSURE THE SITE OF WORKS IS TIDIED AND OBTAIN A CLEARANCE FROM THE CLEAN UP

SUPERVISING ENGINEER OR THE PROJECT MANAGER.

6. DRAINAGE **PIPES**

DRAINAGE PIPES ABOVE 225Ø TO BE MINIMUM OF CLASS 2 REINFORCED CONCRETE, FRCP OR SRCP (RUBBER RING JOINTED) UNLESS OTHERWISE SPECIFIED. DRAINAGE PIPES UP TO 225Ø TO BE SEWER QUALITY UPVC (RUBBER RING JOINTED). COMPACTED CLASS 2 FCR BACKFILL SHALL BE INSTALLED TO PIPES UNDER ROAD PAVEMENTS AND BUILDING SLABS. TRENCHES IN LANDSCAPE AREAS CAN BE BACKFILLED WITH SELECTED CLAY FILL. HDPE PIPES TO BE USED WHEREVER MAX. PIPE FLOWS VELOCITIES EXCEED

EXISTING PIPES

ALL EXISTING PIPES THAT WILL NOW BE BENEATH NEW ROAD PAVEMENT SHALL HAVE THE EXISTING BACKFILL REMOVED AND

REPLACED WITH A CRUSHED ROCK BACKFILL COMPACTED TO 98% STANDARD. DRAINAGE PITS TO BE CAST IN-SITU CONCRETE PITS AS DETAILED OR APPROVED PRECAST CONCRETE COMPLYING WITH THE

RELEVANT AUSTRALIAN STANDARDS. ALL PITS DEEPER THAN 1.0M ARE TO BE PROVIDED WITH APPROVED STEP IRONS AT 300 MAX.

PIT LOCATIONS AND PIPE INVERT LEVELS ARE SPECIFIED ON THE PIT SCHEDULE IN DWG V170115-CI-### AND V170115-CI-###. SET OUT

03 5232 9400

7. TRAFFIC MANAGEMENT GENERAL

TRAFFIC MANAGEMENT SHALL BE ARRANGED BY THE CONTRACTOR FOR THE DURATION OF THE WORKS IN ACCORDANCE WITH AUSTRALIAN STANDARD AS1742.3-2002 FOR CONSTRUCTION TRAFFIC MANAGEMENT AND TO THE SATISFACTION OF ALL PARTIES. INCLUDING THE PROVISION OF ALL NECESSARY SIGNAGE, LIGHTING AND BARRICADING, TRAFFIC FLOWS IN ALL ABUTTING ROADWAYS AND ACCESS TO THE SITE SHALL REMAIN UNIMPEDED FOR THE DURATION OF THE CONTRACT.

8. SERVICES **EXISTING**

ALL STATUTORY AUTHORITY SERVICES MUST BE MAINTAINED AND PROTECTED BY THE CONTRACTOR AT ALL TIMES UNLESS OTHERWISE SHOWN. EXISTING SERVICE LOCATIONS SHOWN HAVE BEEN OBTAINED FROM STATUTORY AUTHORITY RECORDS AND/OR SITE PLANS WHERE AVAILABLE. NO GUARANTEE IS GIVEN THAT ALL EXISTING SERVICES ARE SHOWN AND ALL SERVICES SHOULD BE PROVEN ON SITE PRIOR TO THE COMMENCEMENT OF WORKS IN THEIR VICINITY. CIVIL CONTRACTOR TO CONTACT THE FOLLOWING AUTHORITIES FOR RELOCATION OF CABLES, U/G MAINS OR POLES WHERE

CONTACTS

REQUIRED. OFFICE NO. POWERCOR - BALLARAT 132 206 TELSTRA VICTAS 1800 653 935

Des. | Verif. | Appd.

COLAC OTWAY SHIRE.

ADJUSTMENTS

ALL EXISTING PITS AND SERVICE FITTINGS THAT ARE TO REMAIN WITHIN THE PAVEMENT AREAS SHALL BE REBUILT TO MATCH PROPOSED LEVELS AND WHERE APPLICABLE FITTED WITH AN APPROPRIATE HEAVY DUTY, AUTHORITY APPROVED, COVER. ELSEWHERE EXISTING SERVICES SHALL BE ADJUSTED TO SUIT NEW ADJACENT LEVELS. THE RELEVANT AUTHORITY IS TO BE NOTIFIED PRIOR TO ANY WORKS ON THEIR ASSETS AND SERVICES ARE TO BE ADJUSTED BY OR TO THE RELEVANT AUTHORITY REQUIREMENTS

7. INSPECTIONS

KERBS PROPOSED

EXTERNAL

9. SPECIFICATIONS

10. CONTRACT CONDITIONS GENERAL MAINTENANCE PERIOD

WORKING ON SLOPES

MOVING EQUIPMENT

OPERATING HOURS WORKING IN PRIVATE PROPERTY DRIVEWAYS

ALL WORKS SHALL BE CARRIED OUT IN ACCORDANCE WITH THE APPROVED CONSTRUCTION PROGRAMME TO THE SATISFACTION OF THE SUPERVISING ENGINEER AND SUBJECT TO PERIODICAL INSPECTION AND WRITTEN STAGED APPROVAL. ADDITIONAL

INSPECTIONS CAN BE REQUESTED AT 24 HOURS NOTICE. ALL WORKS IN ROAD RESERVATIONS SHALL REQUIRE WRITTEN APPROVAL OF THE COUNCIL'S SUPERINTENDENT AND ARE SUBJECT TO SEPARATE INSPECTIONS. SEVEN DAYS NOTICE TO BE GIVEN OF WORK COMMENCING. THE CONTRACTOR SHALL OBTAIN ALL NECESSARY ROAD OPENING PERMITS AND AUTHORITY APPROVALS PRIOR TO COMMENCING WORKS

WHERE REQUIRED MATCH ALL NEW KERBS TO EXISTING LEVEL NEATLY, ENSURING MINIMUM 1 IN 250 GRADE, SAW CUTTING AND REINSTATING PAVEMENT IN FRONT OF KERB TO FALL TO NEW KERB LEVEL.

COLAC OTWAY SHIRE AND INFRASTRUCTURE DESIGN MANUAL SPECIFICATIONS SHALL BE USED AS THE GENERAL SPECIFICATION FOR ALL WORKS. IT IS THE CONTRACTOR'S RESPONSIBILITY TO OBTAIN A COPY OF THE CURRENT SPECIFICATIONS, ALL RELEVANT STANDARD DRAWINGS AND ALL ASSOCIATED REVISIONS AND AMENDMENTS ETC.

ALL WORKS SHALL BE CARRIED OUT IN ACCORDANCE WITH AS 4000-1997 GENERAL CONDITIONS OF CONTRACT. A 12 MONTHS MAINTENANCE PERIOD WILL APPLY TO THIS CONTRACT UNLESS NOTED OTHERWISE. CONTRACTOR TO PROVIDE WORK METHOD STATEMENT FOR WORKS ON SLOPES PRIOR TO COMMENCEMENT OF WORKS.

EXCAVATIONS AND OTHER MACHINERY THAT WILL DAMAGE THE ROAD SURFACE IS TO BE FLOATED VIA TRUCK/TRAILOR UNLESS

NO WORK IS TO TAKE PLACE OUTSIDE OF THE FOLLOWING HOURS 7AM-6PM MONDAY-FRIDAY AND 7AM-1PM SATURDAY A MINIMUM 4 DAY NOTICE IS TO BE GIVEN TO RESIDENTS IF WORKS TO BE UNDERTAKEN WITHIN PRIVATE PROPERTY.

RESIDENTS ARE TO BE CONTACTED TO DISCUSS DRIVEWAY COLOUR PREFERENCE, APRON LENGTH AND CONSTRUCTION TIMING.

DRAWING No.	CHEDULE OF DRAWINGS DESCRIPTION
V170115-CI-0001	LOCALITY PLAN
V170115-CI-0002	GENERAL NOTES AND DRAWING SCHEDULE
PITS AND PIPES	SERVICINE HOTEO/MAD DIVINING CONEDUCE
WYE RIVER NORTH	
V170115-CI-1000	WYE RIVER NORTH OVERALL LAYOUT PLAN
V170115-CI-1010	WYE RIVER NORTH DRAINAGE LAYOUT PLAN SHEET 1 OF 4
V170115-CI-1011	WYE RIVER NORTH DRAINAGE LAYOUT PLAN SHEET 2 OF 4
V170115-CI-1012	WYE RIVER NORTH DRAINAGE LAYOUT PLAN SHEET 3 OF 4
V170115-CI-1013	WYE RIVER NORTH DRAINAGE LAYOUT PLAN SHEET 4 OF 4
V170115-CI-1050	WYE RIVER NORTH DRAINAGE INSETS
V170115-CI-1100	WYE RIVER NORTH DRAINAGE TYPICALS SHEET 1 OF 4
V170115-CI-1101	WYE RIVER NORTH DRAINAGE TYPICALS SHEET 2 OF 4
V170115-CI-1102	WYE RIVER NORTH DRAINAGE TYPICALS SHEET 3 OF 4
V170115-CI-1103	WYE RIVER NORTH DRAINAGE TYPICALS SHEET 4 OF 4
V170115-CI-1100	WYE RIVER NORTH DRAINAGE LONGSECTIONS SHEET 1 OF 6
V170115-CI-1201	WYE RIVER NORTH DRAINAGE LONGSECTIONS SHEET 2 OF 6
V170115-CI-1201	WYE RIVER NORTH DRAINAGE LONGSECTIONS SHEET 3 OF 6
V170115-CI-1202	
	WYE RIVER NORTH DRAINAGE LONGSECTIONS SHEET 4 OF 6
V170115-CI-1204 V170115-CI-1205	WYE RIVER NORTH DRAINAGE LONGSECTIONS SHEET 5 OF 6
	WYE RIVER NORTH DRAINAGE BIT SQUEDULE SUIFET 4 OF 8
V170115-CI-1210	WYE RIVER NORTH DRAINAGE PIT SCHEDULE SHEET 1 OF 2
V170115-CI-1211	WYE RIVER NORTH DRAINAGE PIT SCHEDULE SHEET 2 OF 2
V170115-CI-1220	WYE RIVER NORTH DRAINAGE PIT DETAILS SHEET 1 OF 2
V170115-CI-1221	WYE RIVER NORTH DRAINAGE PIT DETAILS SHEET 2 OF 2
WYE RIVER SOUTH	MAYE BIVED COUTH OVER ALL LAYOUT BLAN
V170115-CI-2000	WYE RIVER SOUTH OVERALL LAYOUT PLAN
V170115-CI-2010	WYE RIVER SOUTH DRAINAGE LAYOUT PLAN SHEET 1 OF 2
V170115-CI-2011	WYE RIVER SOUTH DRAINAGE LAYOUT PLAN SHEET 2 OF 2
V170115-CI-2100	WYE RIVER SOUTH DRAINAGE TYPICALS SHEET 1 OF 4
V170115-CI-2101	WYE RIVER SOUTH DRAINAGE TYPICALS SHEET 2 OF 4
V170115-CI-2102	WYE RIVER SOUTH DRAINAGE TYPICALS SHEET 3 OF 4
V170115-CI-2103	WYE RIVER SOUTH DRAINAGE TYPICALS SHEET 4 OF 4
V170115-CI-2200	WYE RIVER SOUTH DRAINAGE LONGSECTIONS
V170115-CI-2210	WYE RIVER SOUTH DRAINAGE PIT SCHEDULE
V170115-CI-2220	WYE RIVER SOUTH DRAINAGE PIT DETAILS
SEPARATION CREEK	
V170115-CI-3000	SEPARATION CREEK OVERALL LAYOUT PLAN
V170115-CI-3010	SEPARATION CREEK DRAINAGE DETAILED LAYOUT PLAN SHEET 1 OF
V170115-CI-3011	SEPARATION CREEK DRAINAGE DETAILED LAYOUT PLAN SHEET 2 OF
V170115-CI-3100	SEPARATION CREEK DRAINAGE TYPICALS SHEET 1 OF 4
V170115-CI-3101	SEPARATION CREEK DRAINAGE TYPICALS SHEET 2 OF 4
V170115-CI-3102	SEPARATION CREEK DRAINAGE TYPICALS SHEET 3 OF 4
V170115-CI-3103	SEPARATION CREEK DRAINAGE TYPICALS SHEET 4 OF 4
V170115-CI-3200	SEPARATION CREEK DRAINAGE LONGSECTIONS SHEET 1 OF 2
V170115-CI-3201	SEPARATION CREEK DRAINAGE LONGSECTIONS SHEET 2 OF 2
V170115-CI-3210	SEPARATION CREEK DRAINAGE PIT SCHEDULE
V170115-CI-3220	SEPARATION CREEK DRAINAGE PIT DETAILS

WARNING

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25/10/2017 | FOR TENDER E.H E.H FOR TENDER 18/10/2017

Description

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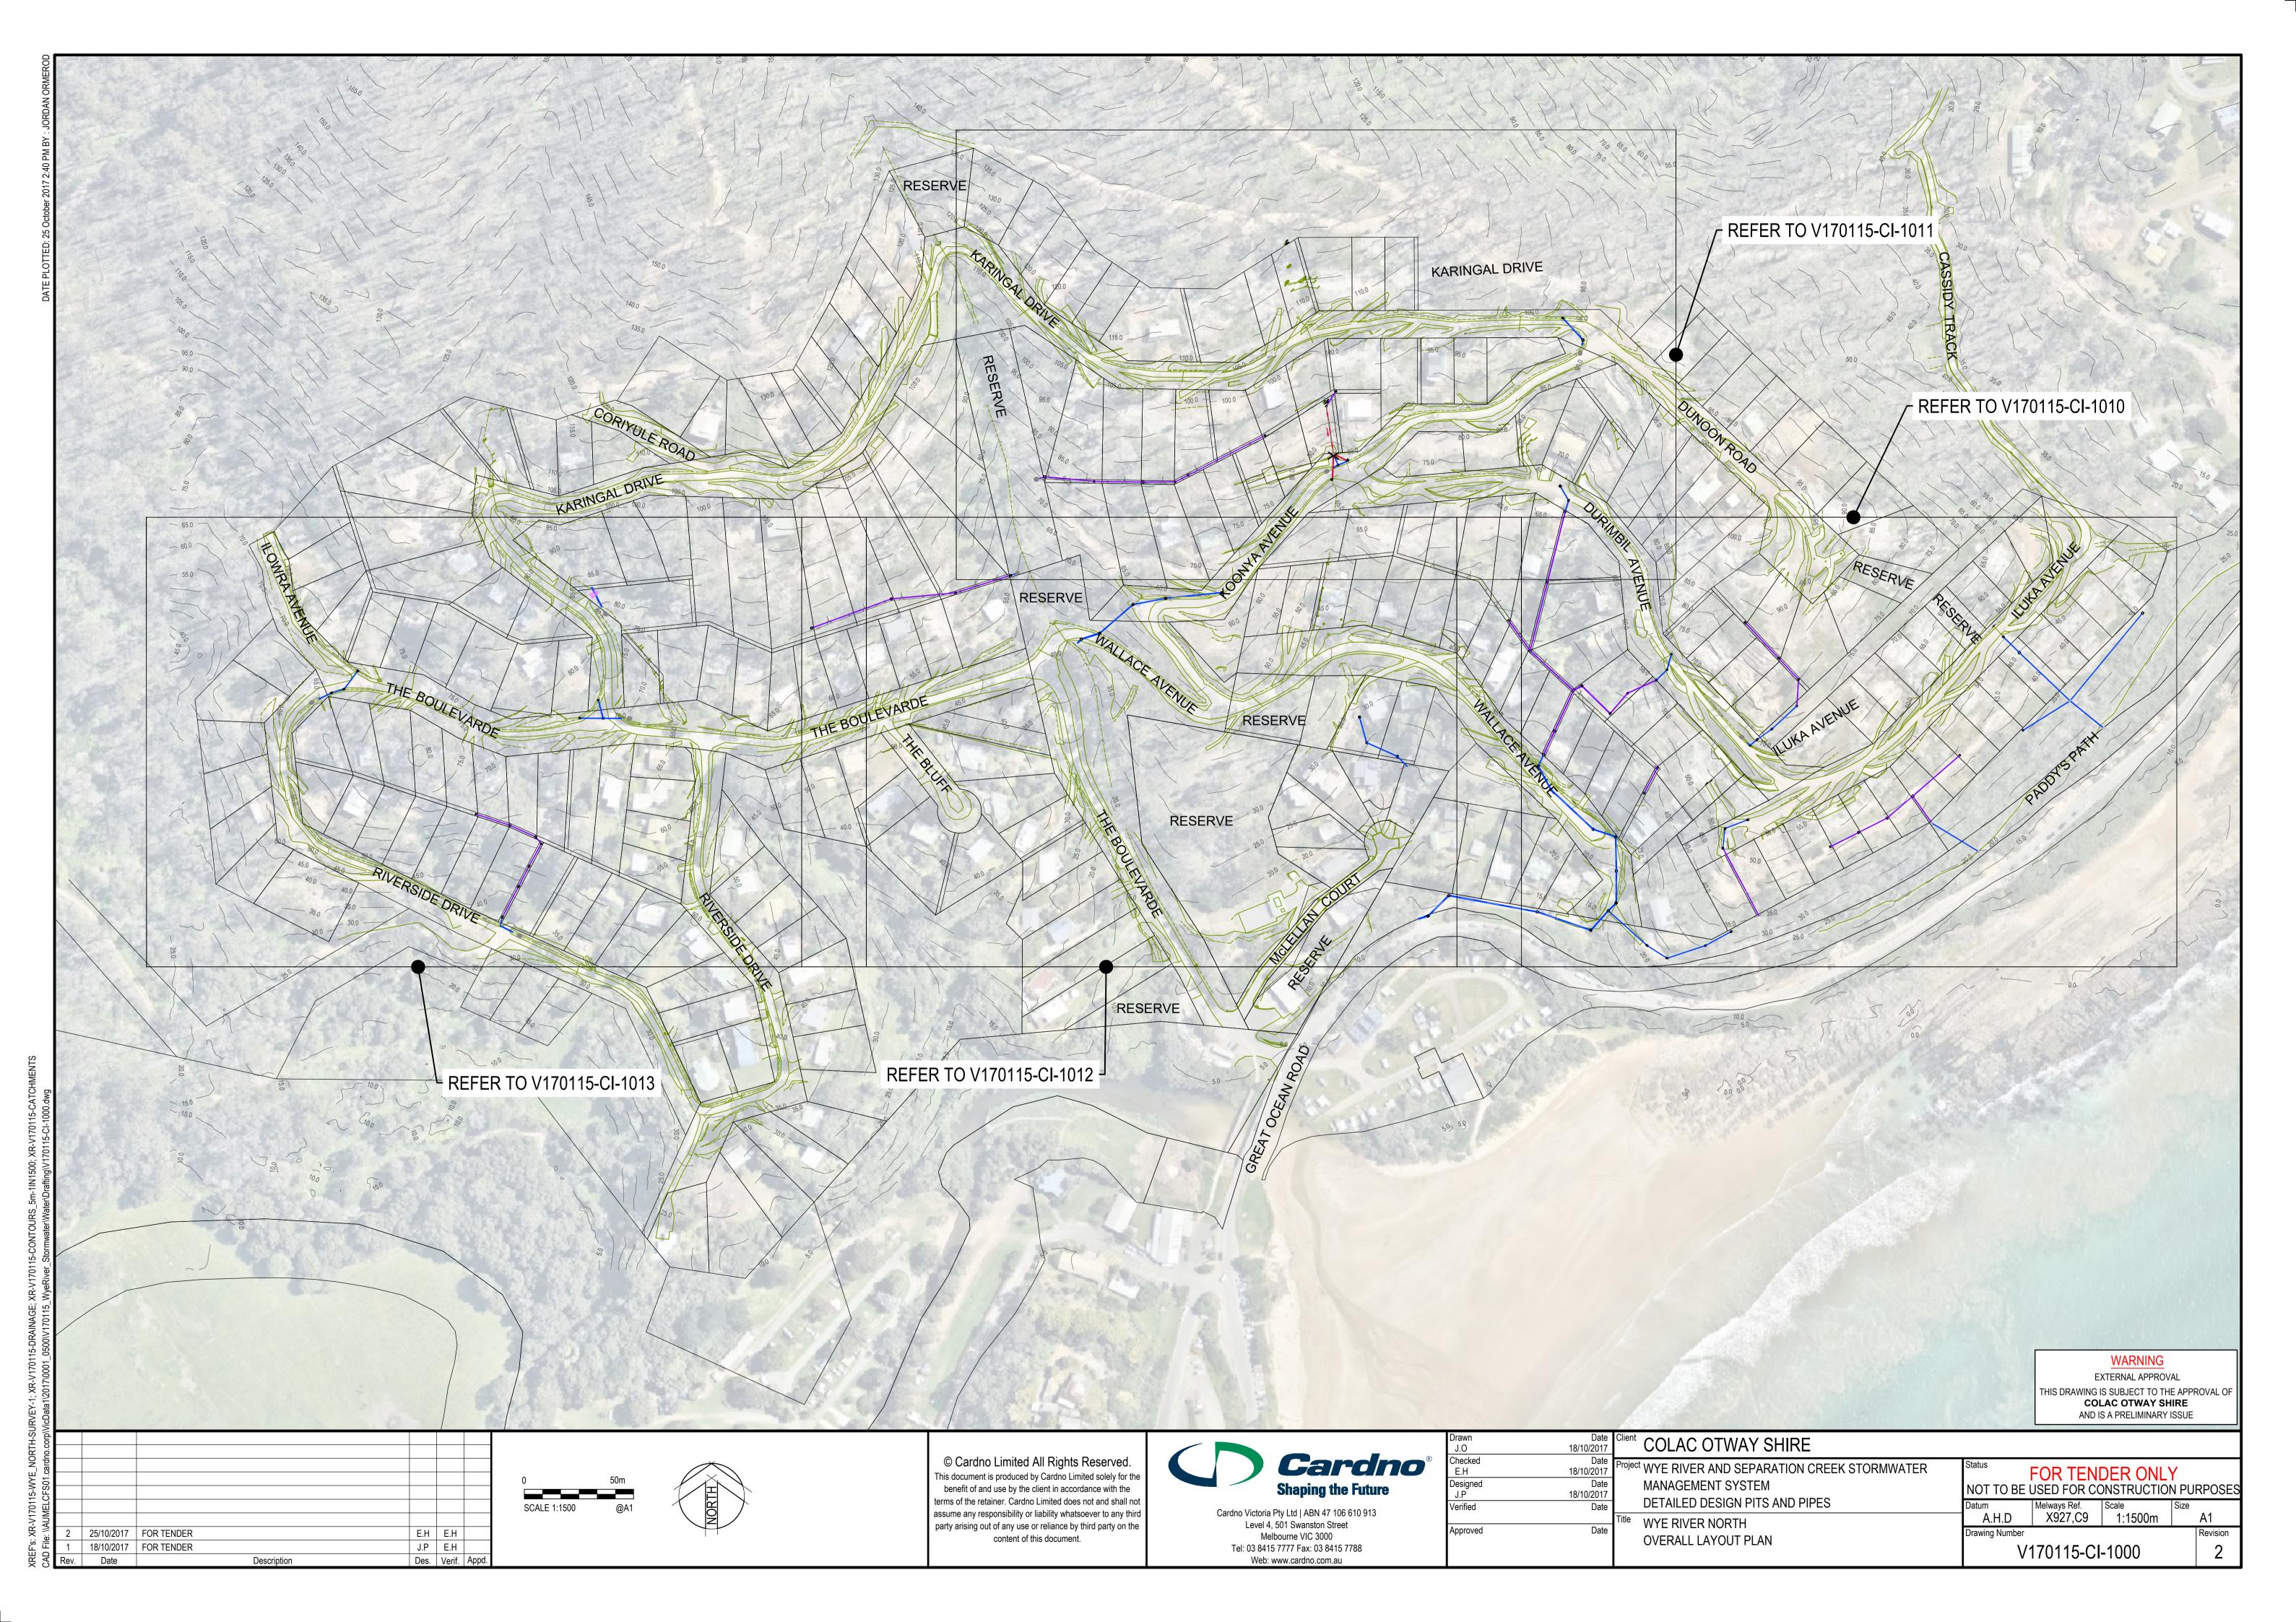
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E.H	18/10/2017
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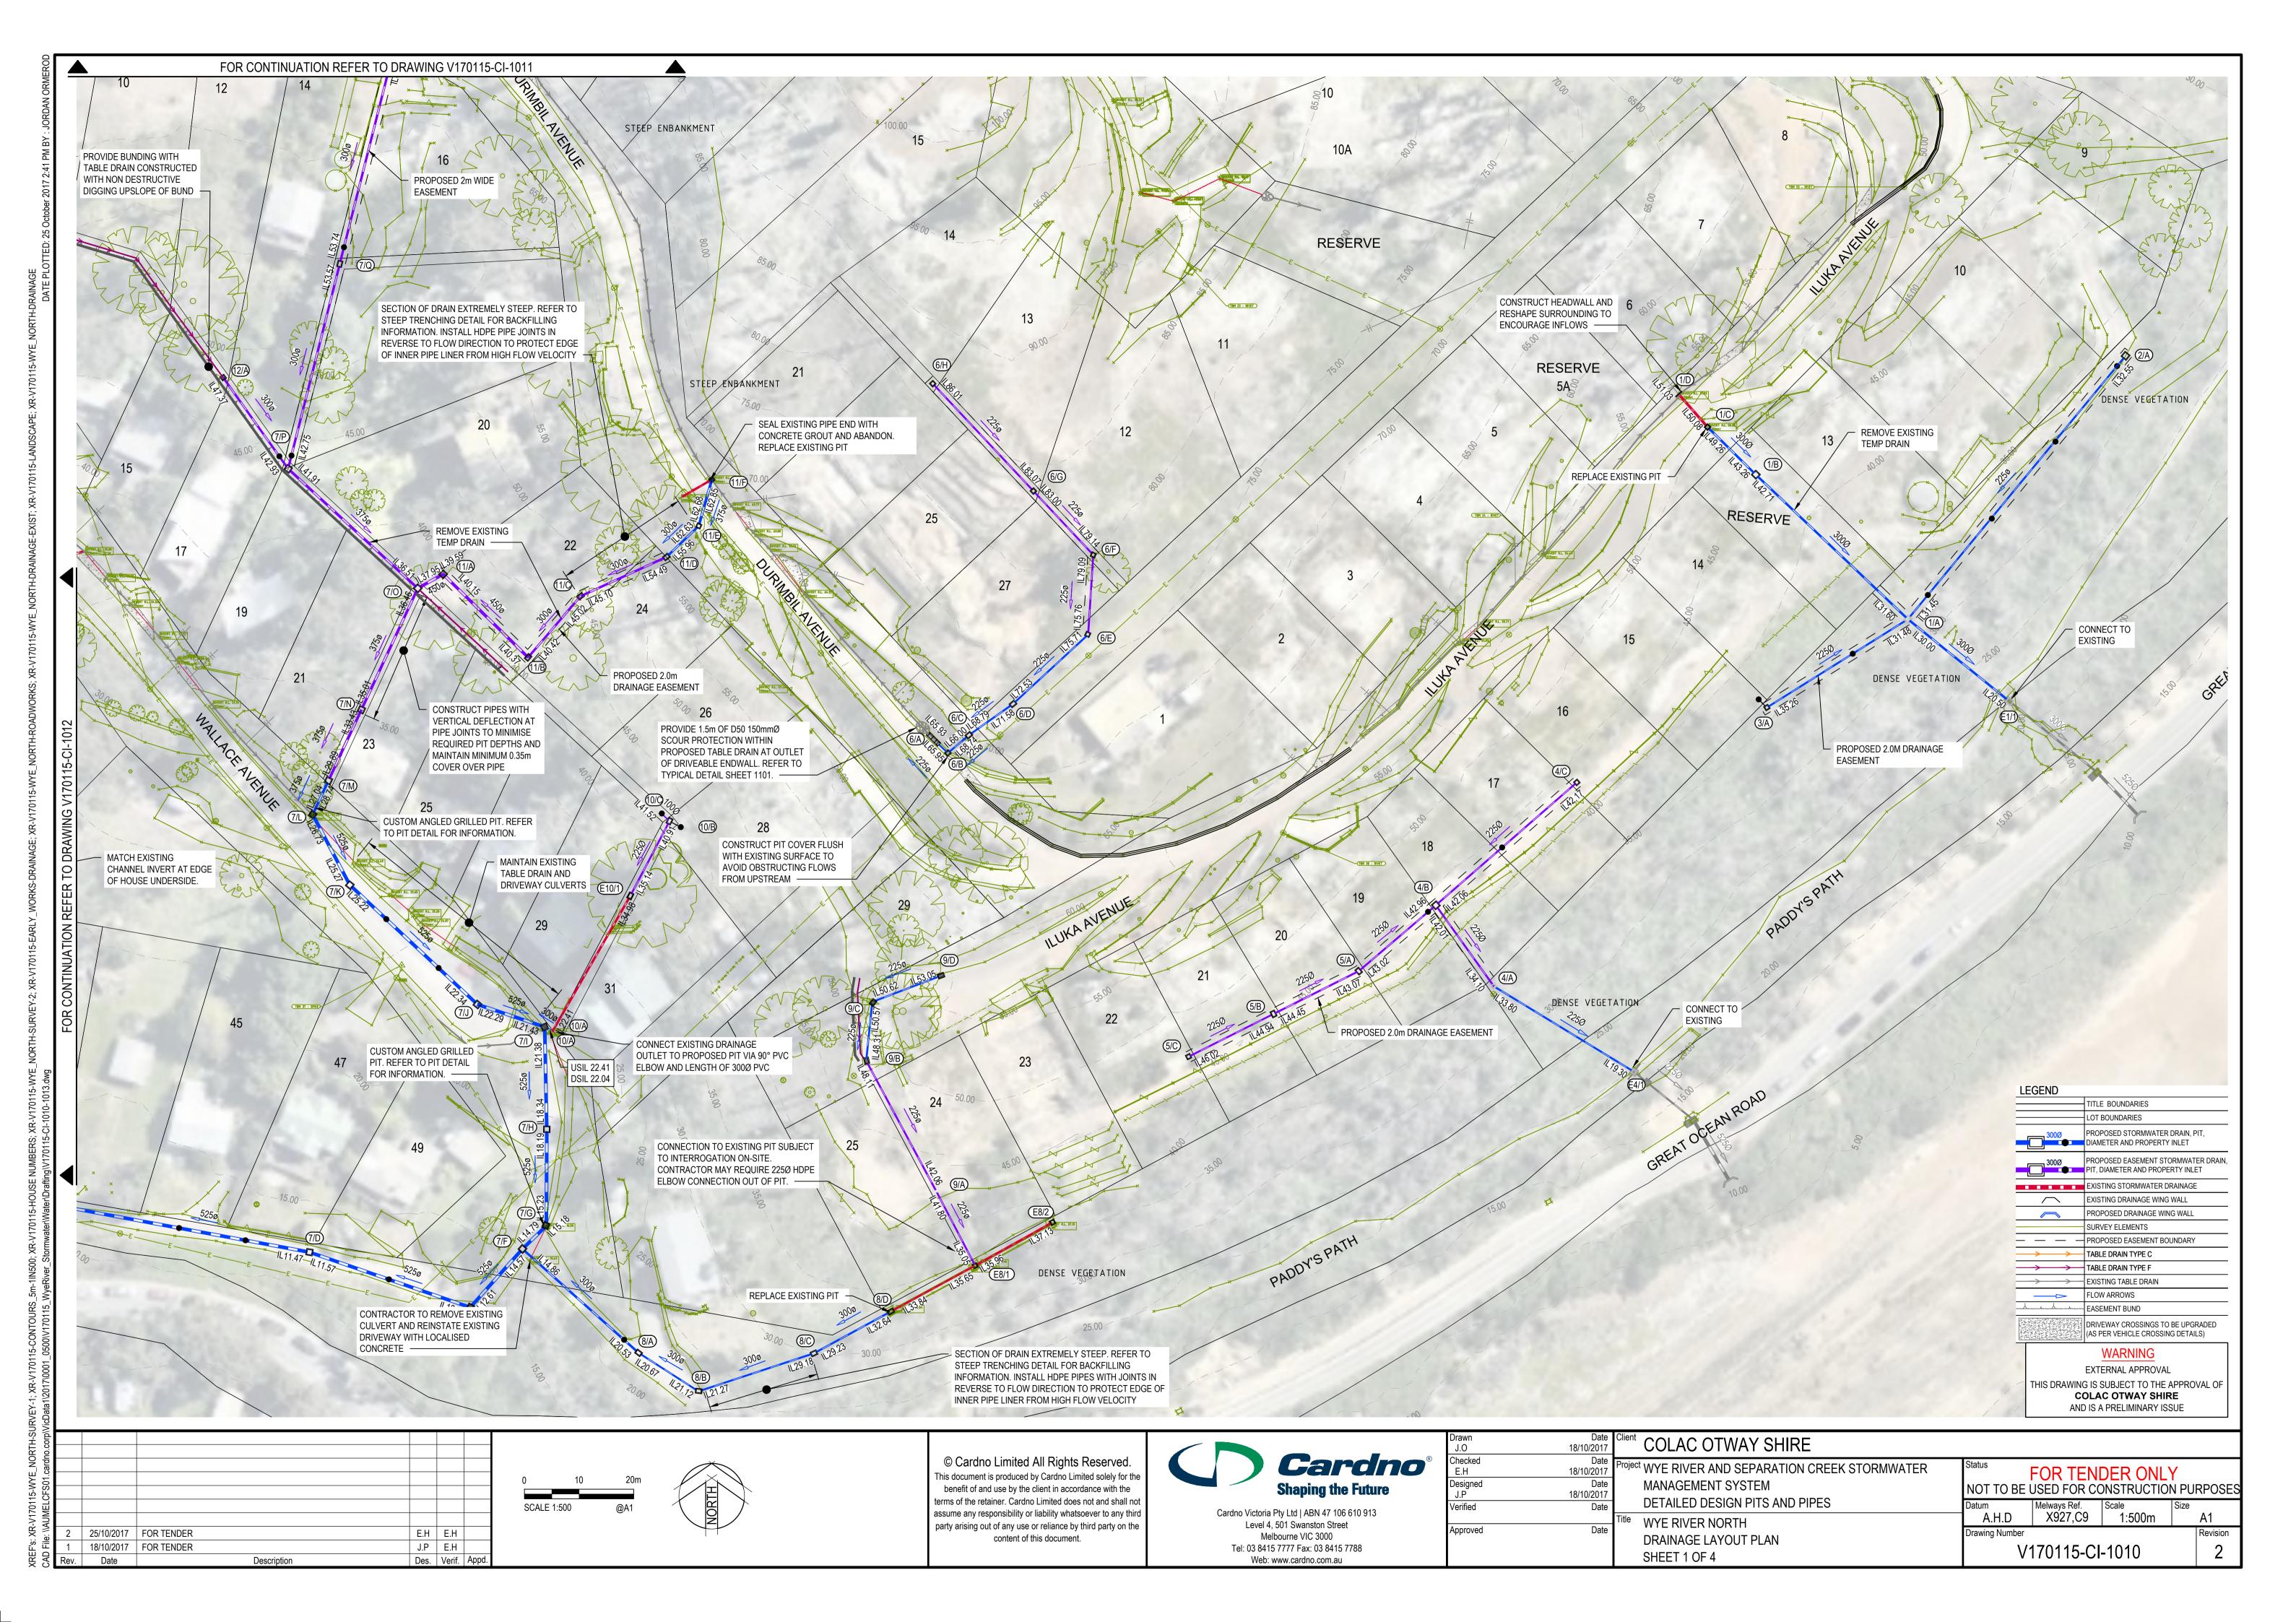
COLAC OTWAY SHIRE Ject Wye River and Separation Creek Stormwater MANAGEMENT SYSTEM DETAILED DESIGN PITS AND PIPES


GENERAL NOTES AND DRAWING SCHEDULE


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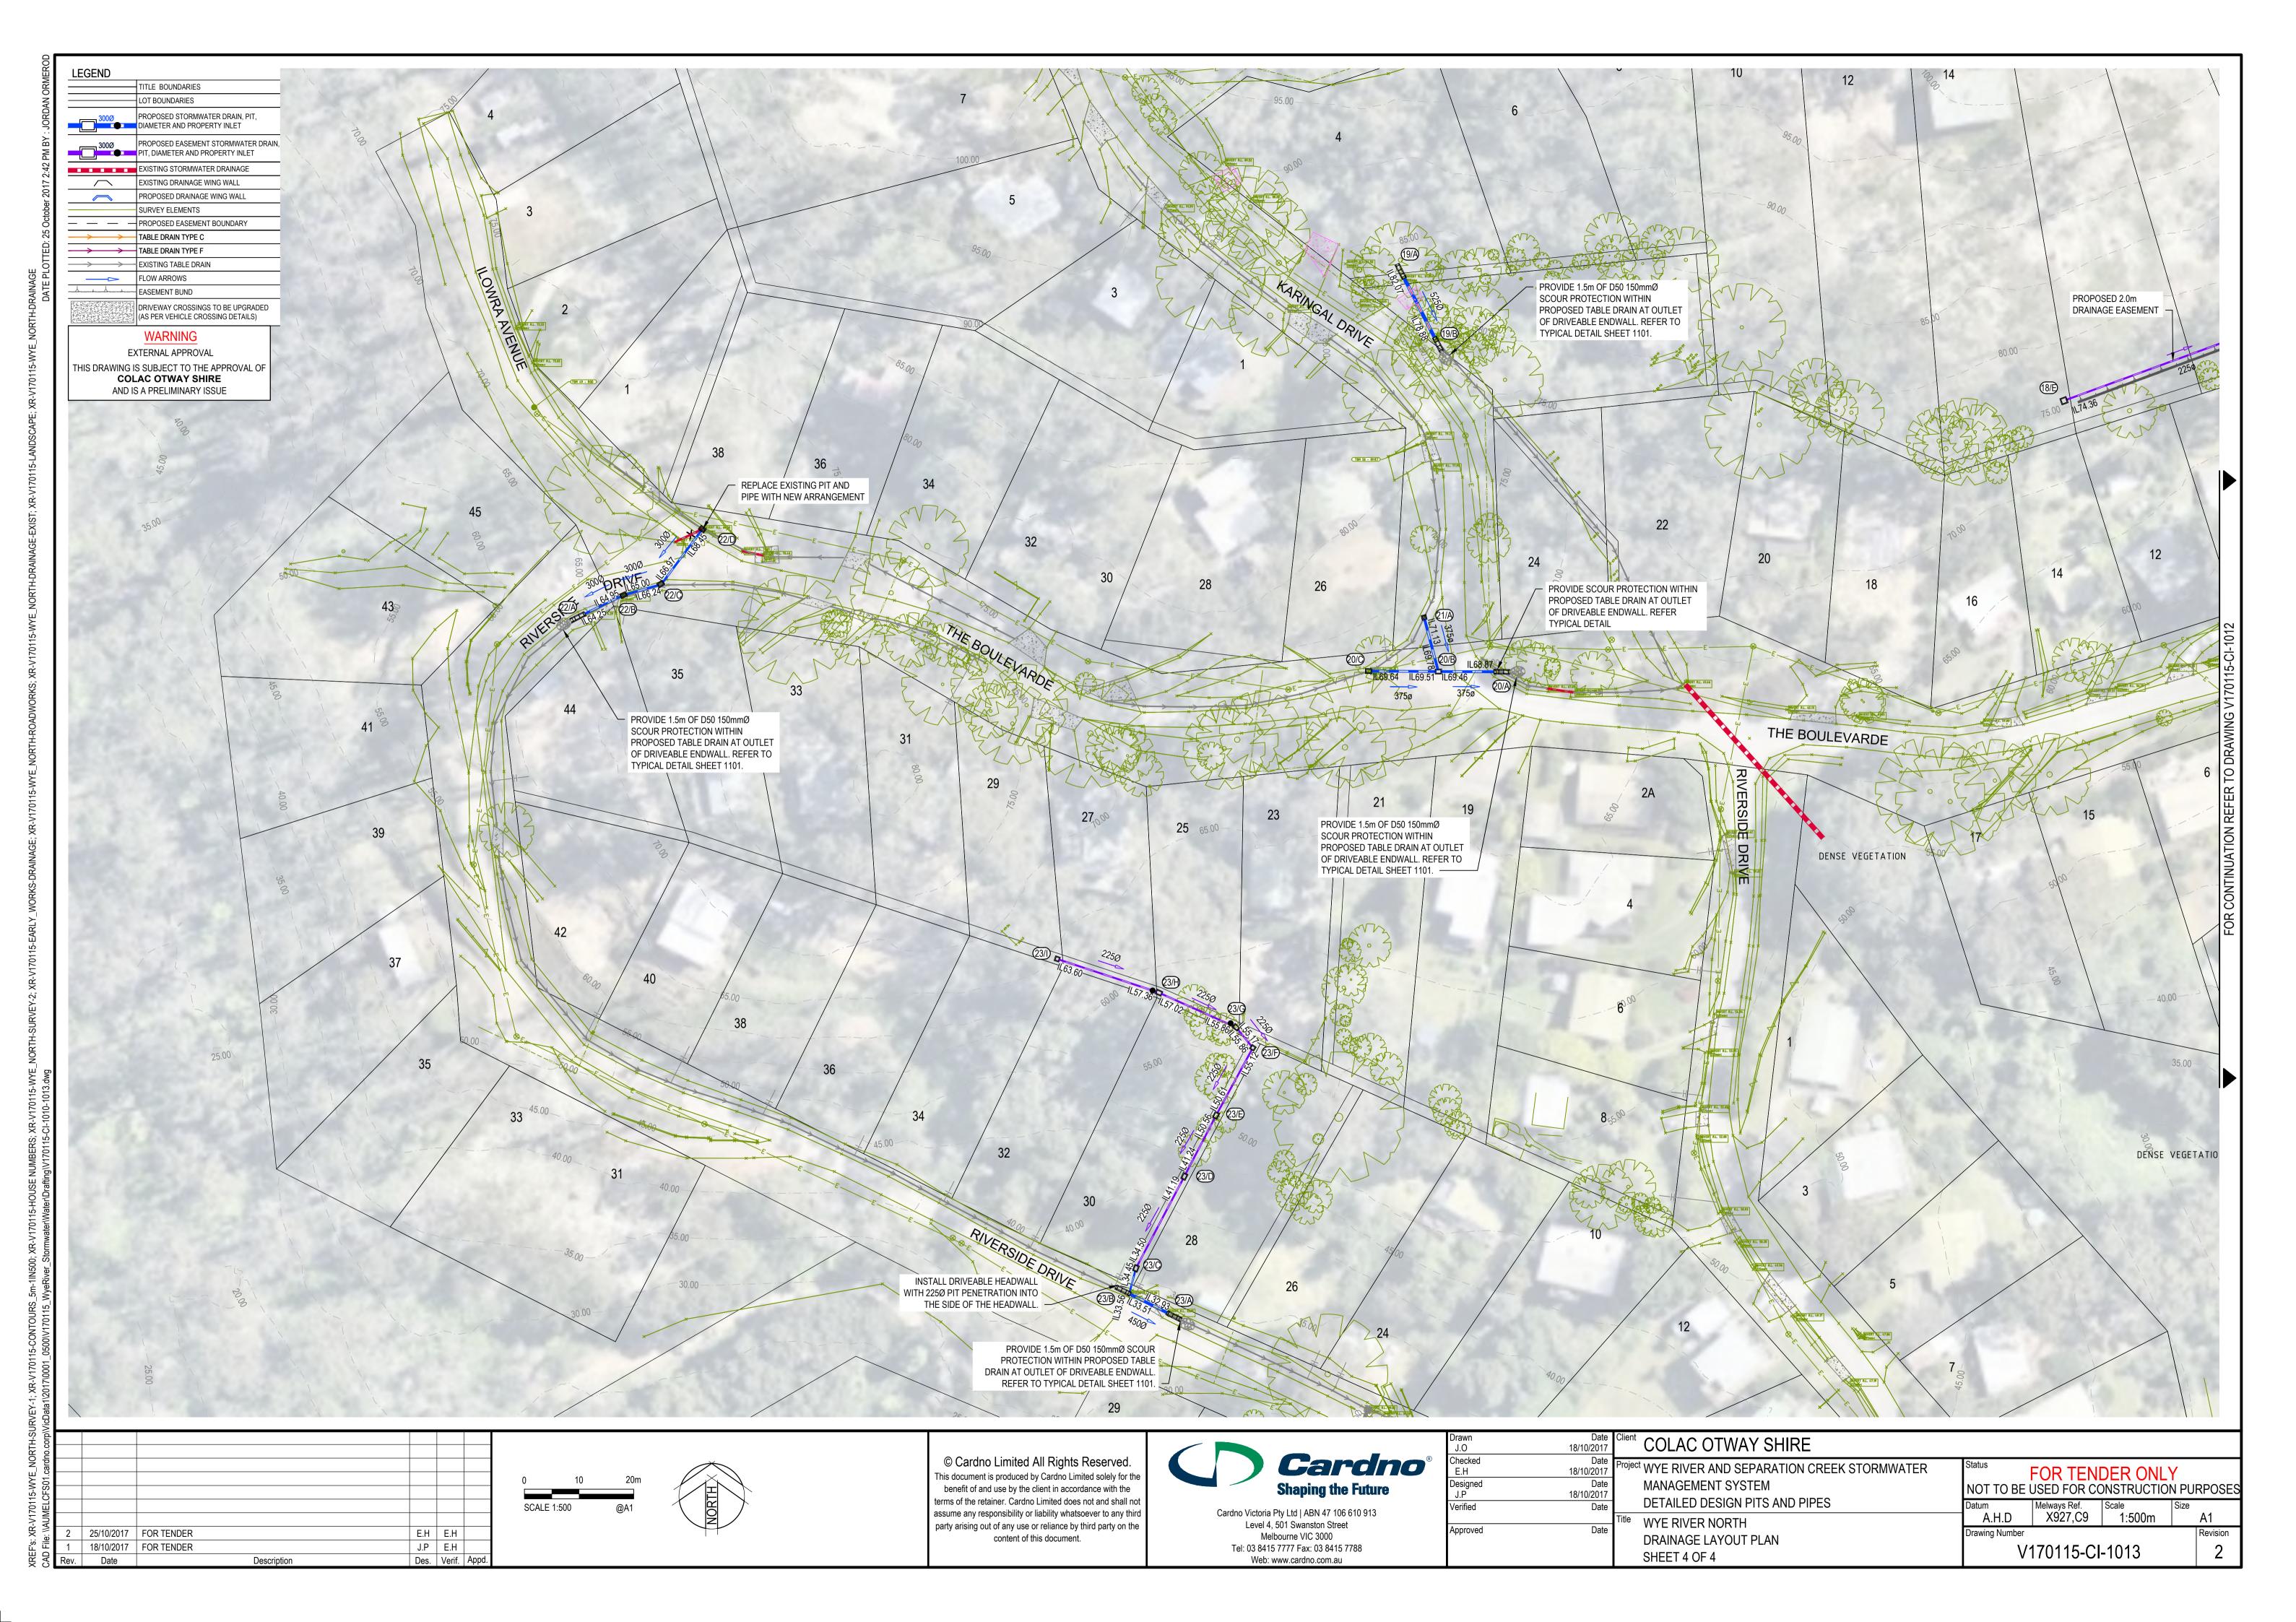
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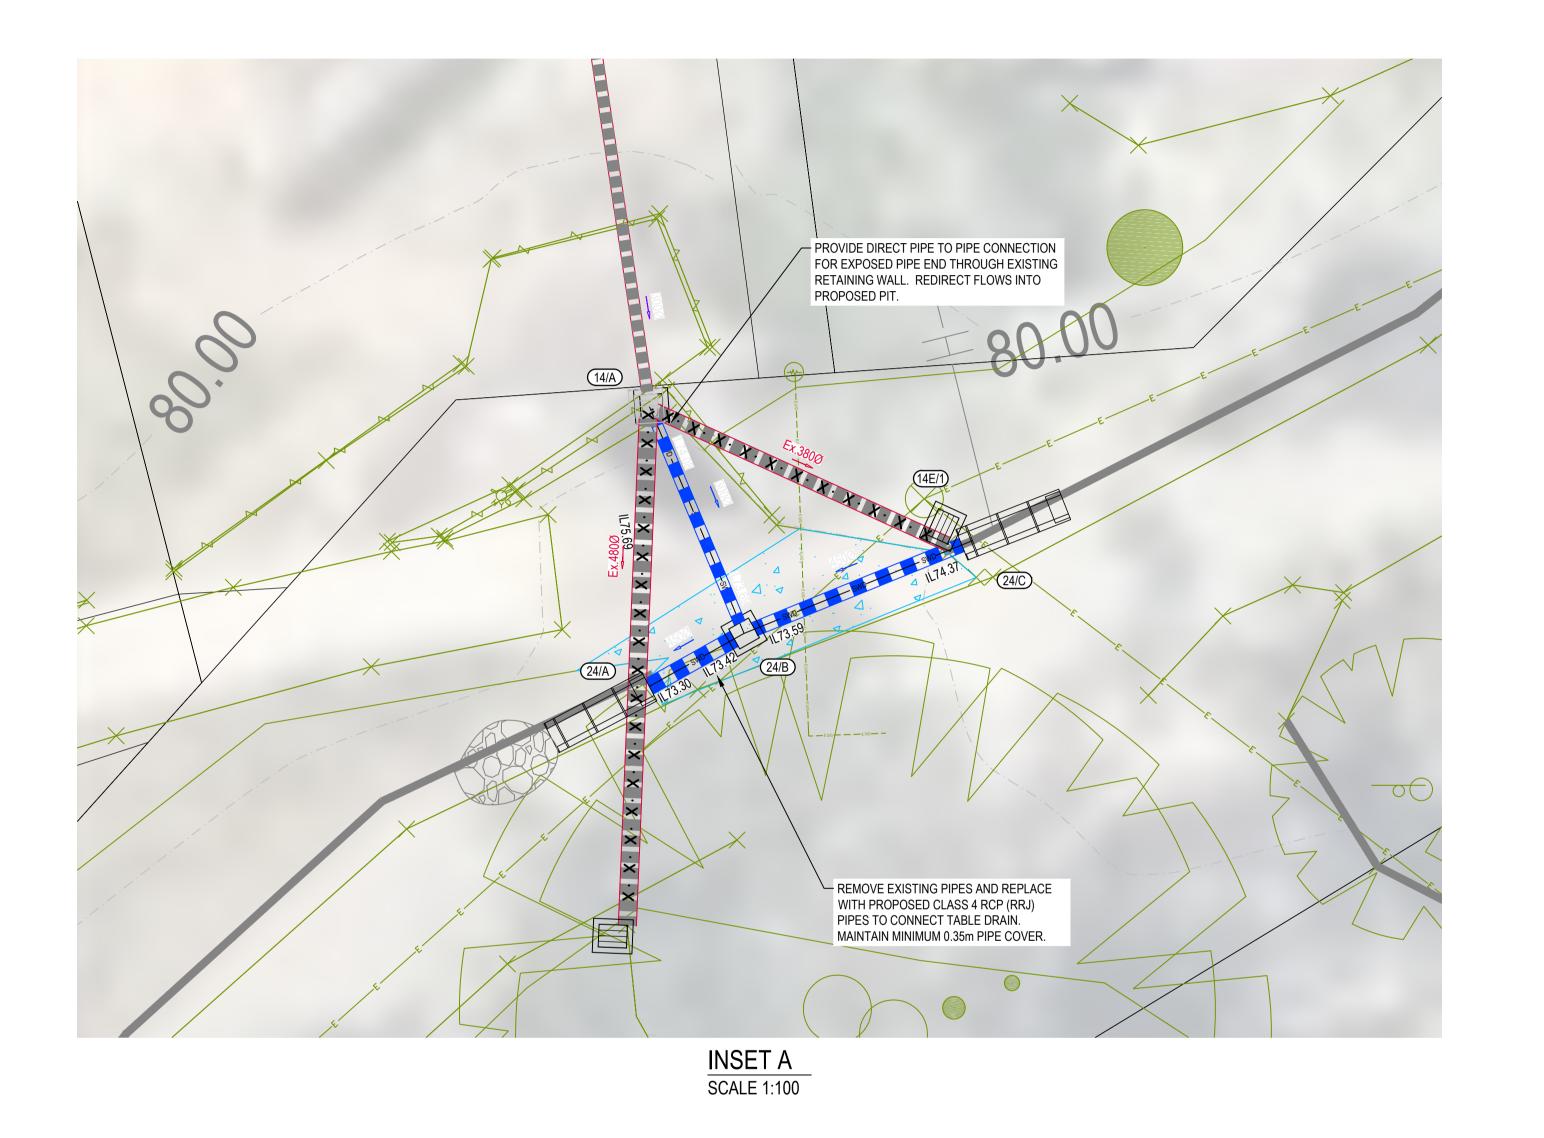








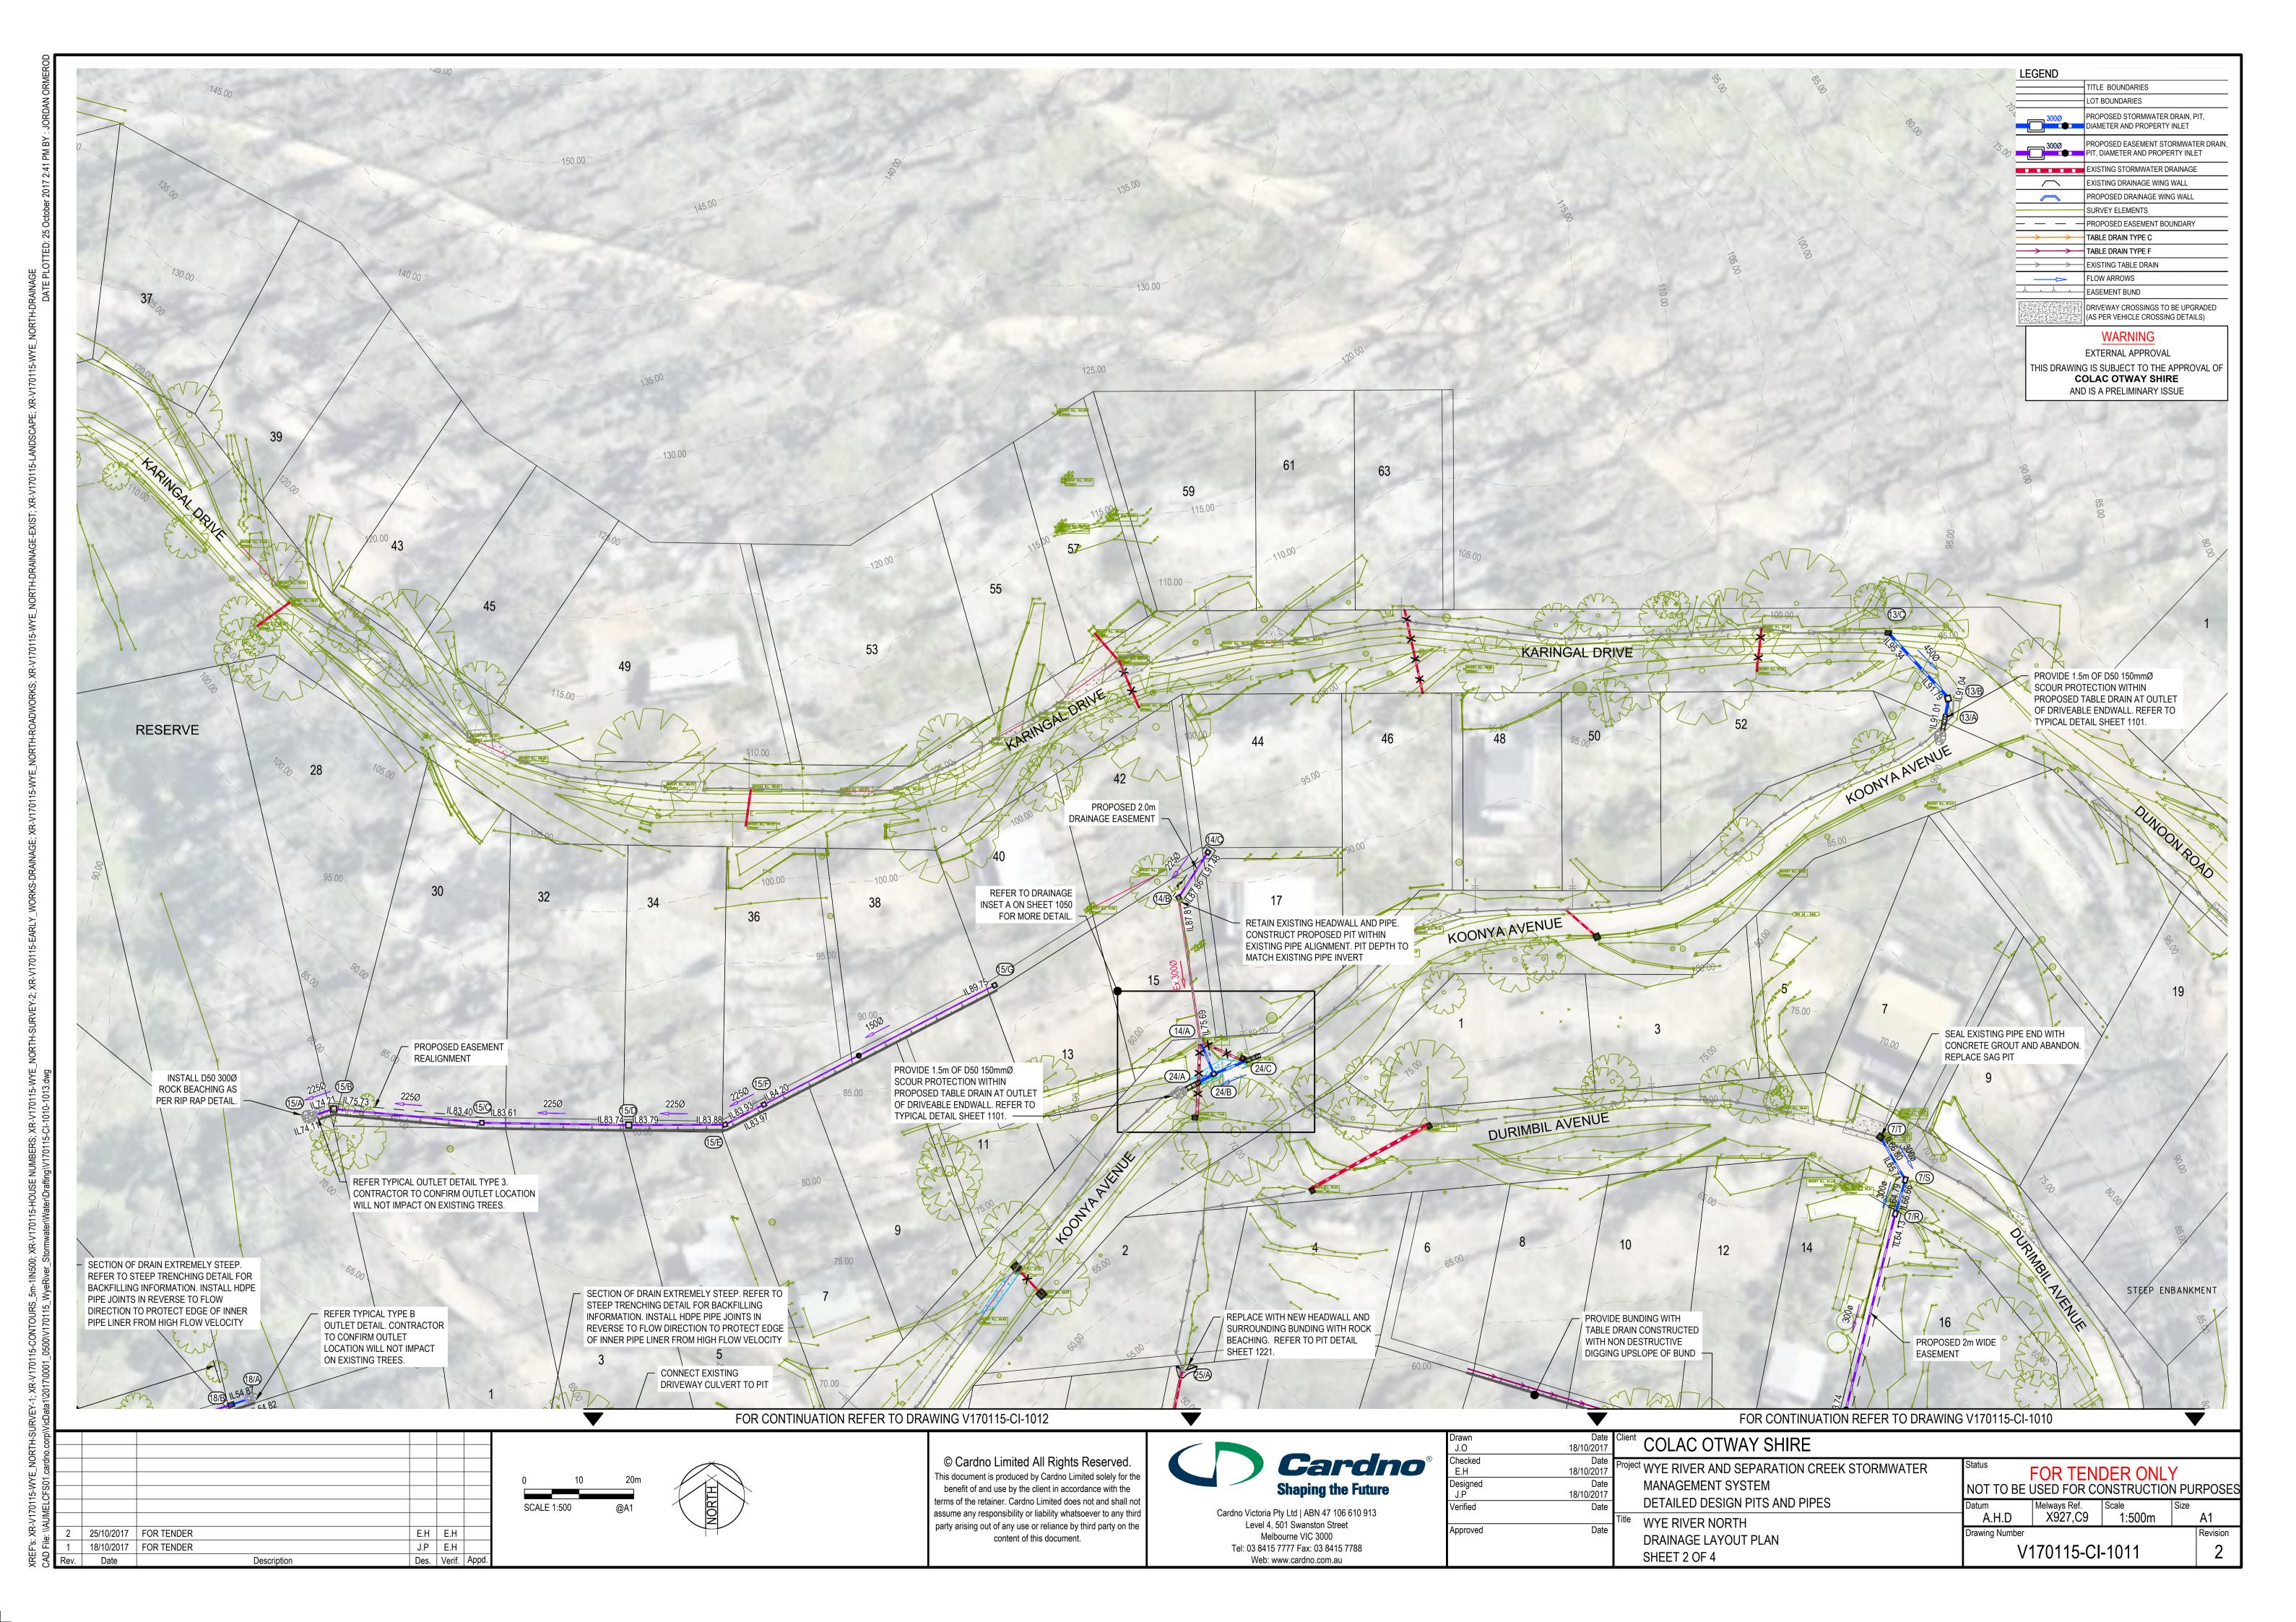

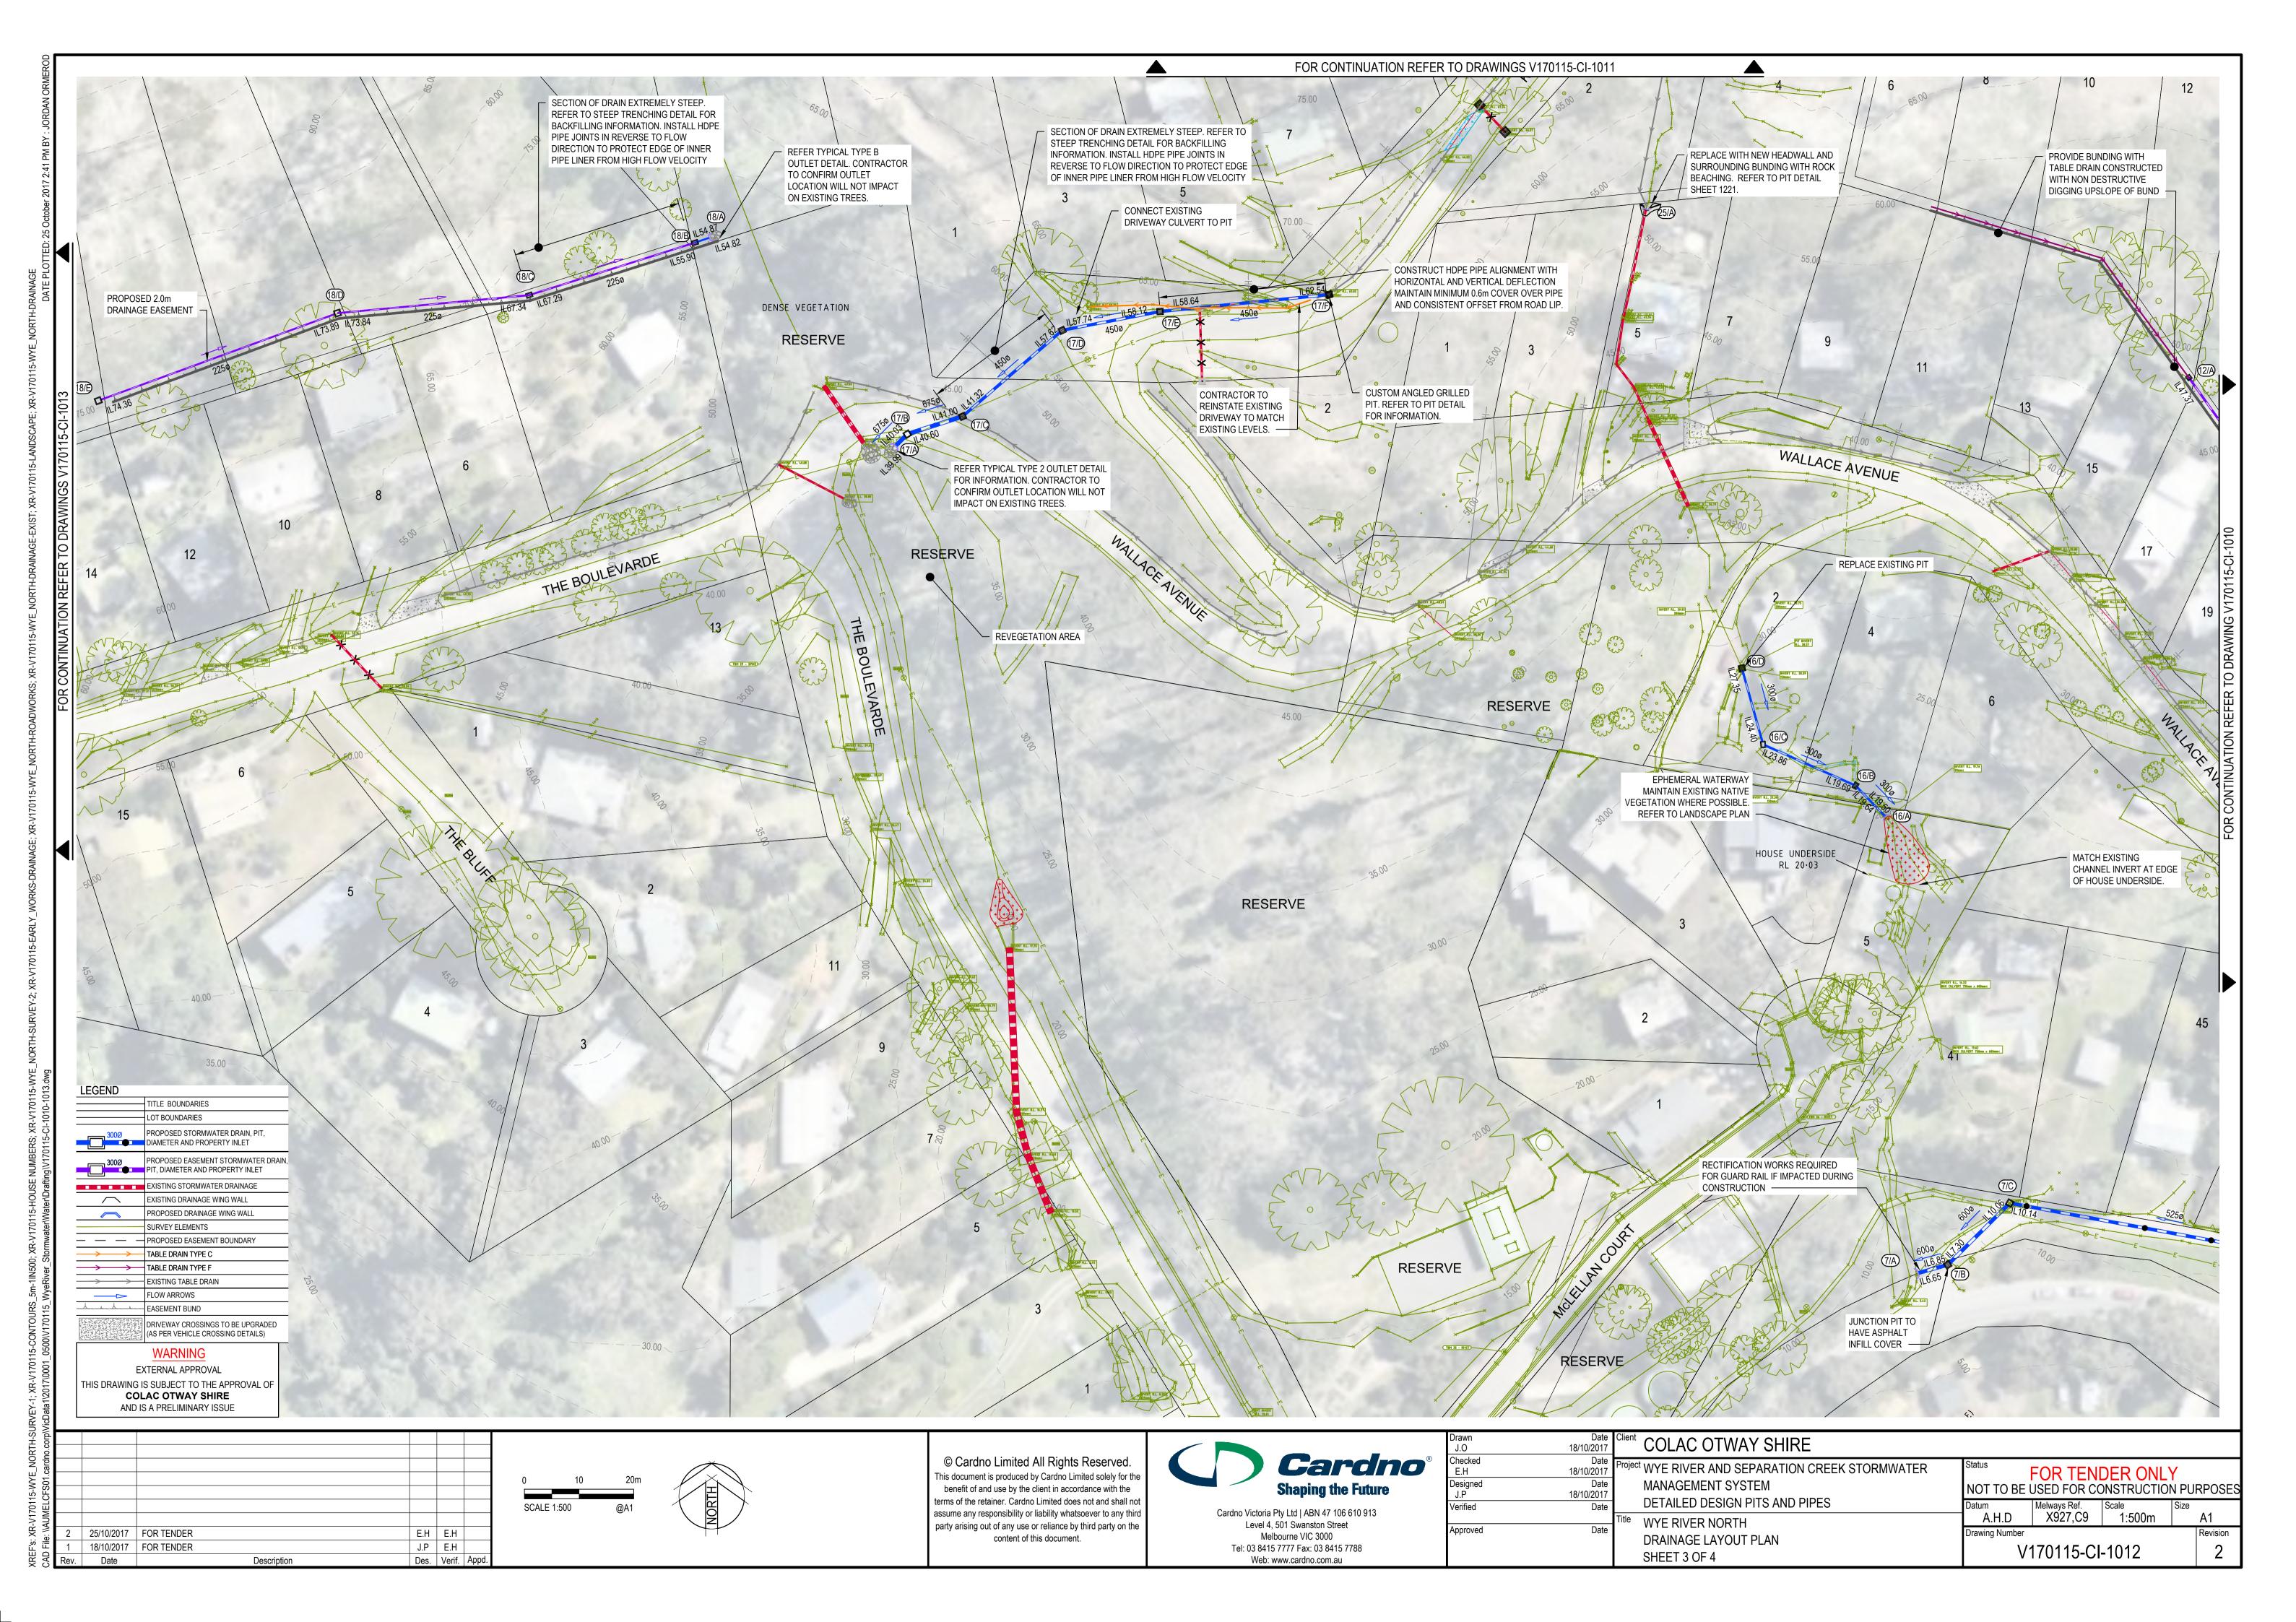

TITLE BOUNDARIES LOT BOUNDARIES PROPOSED STORMWATER DRAIN, PIT, DIAMETER AND PROPERTY INLET PROPOSED EASEMENT STORMWATER DRAIN,
PIT, DIAMETER AND PROPERTY INLET EXISTING STORMWATER DRAINAGE EXISTING DRAINAGE WING WALL PROPOSED DRAINAGE WING WALL SURVEY ELEMENTS — — EASEMENT BOUNDARY

TABLE DRAIN TYPE A TABLE DRAIN TYPE A TABLE DRAIN TYPE B TABLE DRAIN TYPE C TABLE DRAIN TYPE D TABLE DRAIN TYPE E TABLE DRAIN TYPE F TABLE DRAIN TYPE G TABLE DRAIN TYPE H — – — TABLE DRAIN CENTRELINE > EXISTING TABLE DRAIN
TABLE DRAIN FLOW ARROWS BARRIER KERB EXISTING BARRIER KERB >> SPOON DRAIN
>> EXISTING SPOON DRAIN KERB AND CHANNEL EASEMENT BUND DRIVEWAY CROSSINGS TO BE UPGRADED
(AS PER VEHICLE CROSSING DETAILS) WARNING EXTERNAL APPROVAL

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J.P	18/10/2017
Verified	Date
Approved	Date

Date 18/10/2017


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roject	WYE RIVER AND SEPARATION CREEK STORMWATER
	MANAGEMENT SYSTEM
	DETAILED DESIGN PITS AND PIPES
ïtle	WYE RIVER NORTH
	DRAINAGE INSETS


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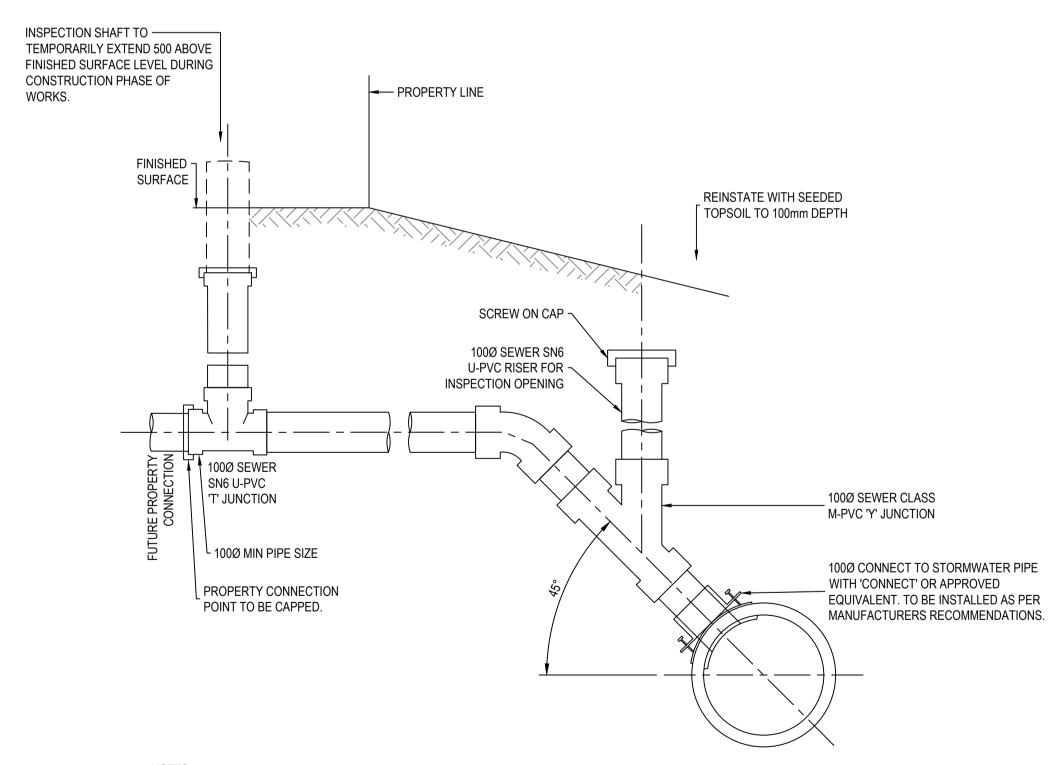
NORTH





WITH COVER GREATER THAN 600mm

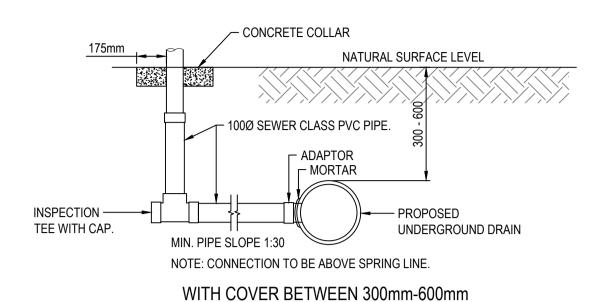
PIPE TO PIPE CONNECTION DETAIL NOT TO SCALE

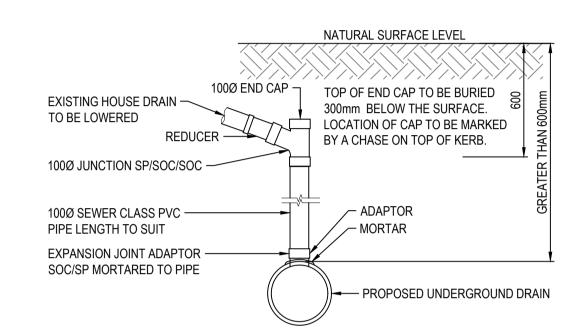


1. REFER TO PLUMBING CODE OF AUSTRALIA FOR ALL PIPE LAYING AND JOINTING REQUIREMENTS.

TRUNK DRAIN CONNECTION

(45° TO PIPE WHERE COVER LIMITED OR STEEP GROUND) NOT TO SCALE

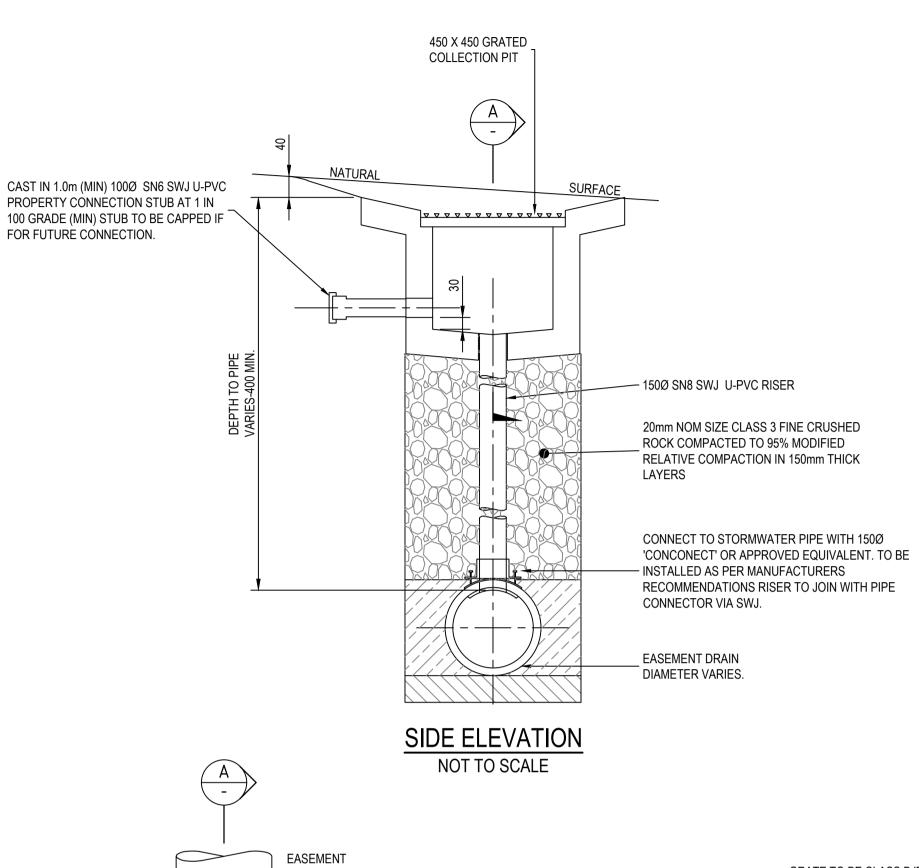

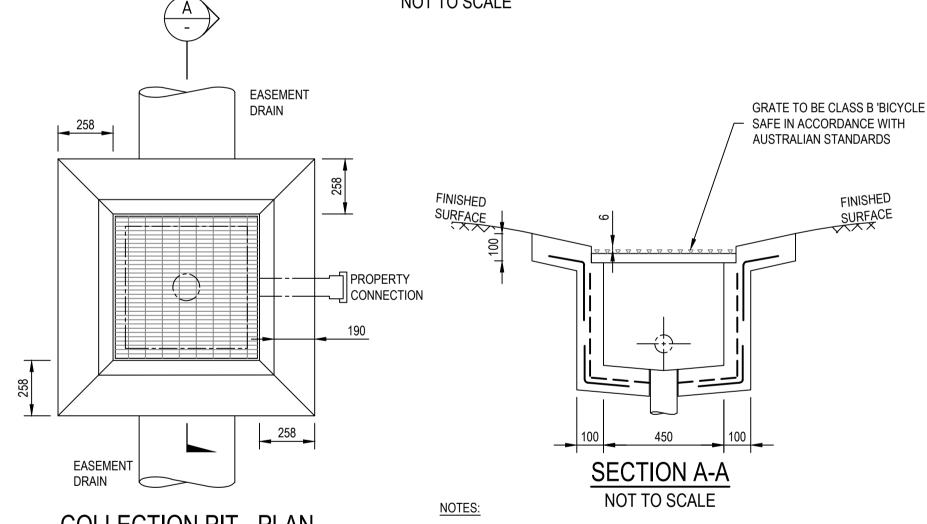

COLLECTION PIT - PLAN NOT TO SCALE

EDGE CONCRETE AROUND PERIMETER OF GRATE

- TOP OF GRATE 40mm (min) BELOW FINISHED SURFACE.
- DO NOT BOND GRATE TO CONCRETE TO ALLOW EASY ACCESS TO PIT. CONCRETE TO BE SMOOTH TROWELLED FINISH.
- GRATE FRAME TO BE OILED IF INSTALLED IN WET CONCRETE.
- CONCRETE STRENGTH F'C = 25MPa. (MIN) AT 28 DAYS
- SEAL UP AND MAKE GOOD PIPE CONNECTION / INSERTION TO PIT. 8. PROPERTY CONNECTION MIN 100Ø PIPE AS PER CLAUSE 16.10.2 (PIPE DIAMETERS).

EASEMENT DRAIN CONNECTION - PITS

NOT TO SCALE

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25/10/2017 FOR TENDER E.H E.H 18/10/2017 FOR TENDER J.P E.H Date Description Des. Verif. Appd.

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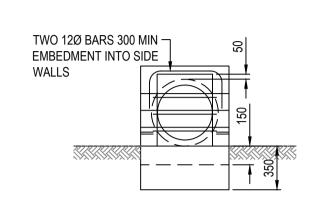
COLAC OTWAY SHIRE Diect WYE RIVER AND SEPARATION CREEK STORMWATER MANAGEMENT SYSTEM DETAILED DESIGN PITS AND PIPES WYE RIVER NORTH

DRAINAGE TYPICALS


SHEET 1 OF 4


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X927,C9 AS SHOWN A1 V170115-CI-1100



ELEVATION



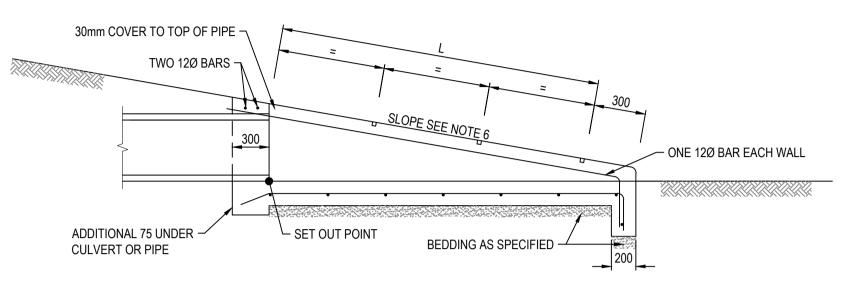

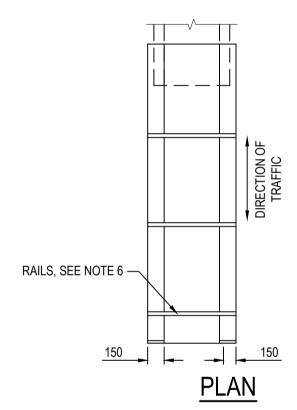NOTES:

1. REINFORCEMENT, SL81 UNLESS OTHERWISE SPECIFIED, SHALL BE CONTINUOUS AROUND CORNERS AND LOCATED AS SHOWN.

CLEAR COVER 50 MIN. LAPS, FABRICS 300 MIN., BARS 25XBAR

DIAMETER MIN.
 CONCRETE STRENGTH N32 AT 28 DAYS

EXPOSED EDGES SHALL HAVE 20x20 CHAMFERS


RAILS WITHIN SECTION "L" SHALL BE EVENLY SPACED. THE MAXIMUM SPACING SHALL NOT EXCEED 600mm.

6. RAILS ARE 60.3mm DIAMETER GALVANIZED TUBES 5.4mm THICK. THESE ARE TO BE GROUTED INTO THE SLOTS IN THE WALLS.


SLOPE OF ENDWALL TO MATCH BATTER SLOPE MAXIMUM SLOPE 4 TO 1.


TOTAL NUMBER OF RAILS
1
2
3
4


DRIVEABLE ENDWALL TYPE 1 NOT TO SCALE

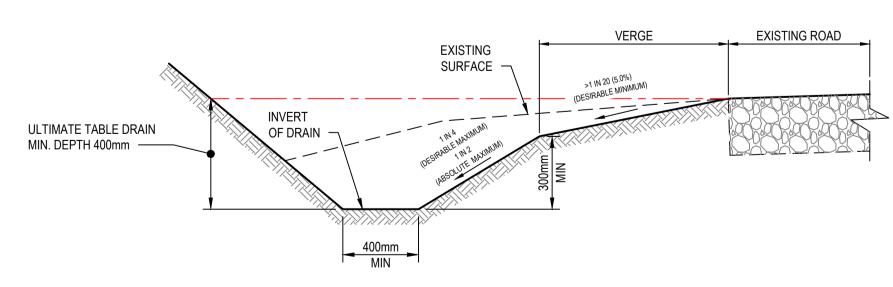

TYPICAL TABLE DRAIN (TYPE-C)
NOT TO SCALE

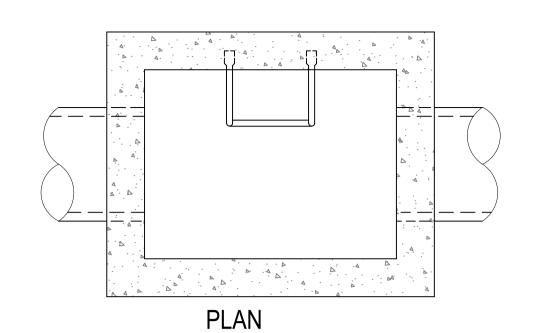

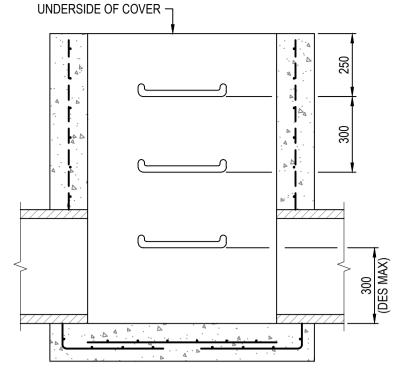

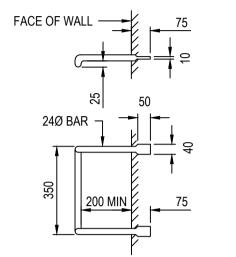

NOTES:

1. PITS DEEPER THAN 1000mm SHALL BE FITTED WITH STEP IRONS.


STEP IRONS SHALL BE LOCATED:
 DIRECTLY BELOW THE OPENING IN THE COVER
 DESIRABLY ON A WALL WITHOUT PIPE OPENINGS

- DESIRABLY ON ONE OF THE LONG SIDES OF THE PIT MATERIAL FOR STEP IRONS SHALL BE STRUCTURAL GRADE 250 TO AS 1204.

4. STEP IRONS SHALL HAVE SHARP EDGES ROUNDED AND HOT DIP GALVANIZED AFTER FABRICATION.


5. PROPRIETY STEPS SUCH AS THE GATIC PS2-PF POLYPROPYLENE STEPS (OR APPROVED ALTERNATIVE)
MAY BE USED. THESE SHALL BE INSTALLED ACCORDING TO THE MAUFACTUREERS INSTRUCTIONS.

STEP IRON DETAIL NOT TO SCALE

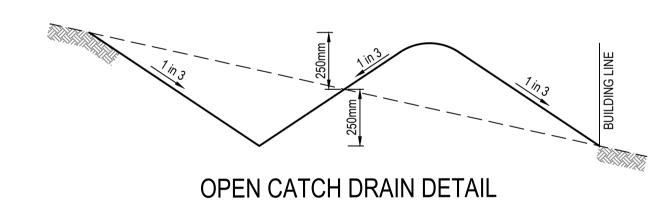

NOT TO SCALE

NOTE: CATCH DRAINS TO BE GRADED TO NOMINATED OUTLETS. FINISH WITH 100mm TOPSOIL

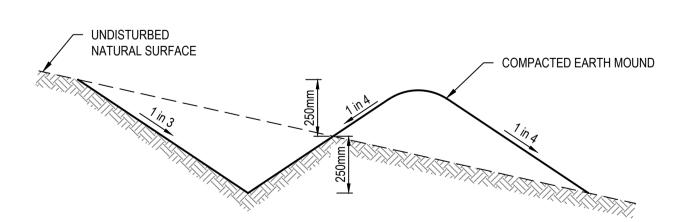

TYPICAL MOUNDED CATCH DRAIN(TYPE-F)

NOT TO SCALE

NOTE: DRAINS TO BE GRADED TO NOMINATED OUTLETS. FINISH WITH 100mm TOPSOIL

WARNING

EXTERNAL APPROVAL

THIS DRAWING IS SUBJECT TO THE APPROVAL OF

COLAC OTWAY SHIRE

AND IS A PRELIMINARY ISSUE

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	1	18/10/2017	FOR TENDER	J.P	E.H	
A	Rev.	Date	Description	Des.	Verif.	Appd.

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	J.O	18/10/2017
R	Checked	Date
Į.	E.H	18/10/2017
	Designed	Date
	J.P	18/10/2017
	Verified	Date
	Approved	Date

Client COLAC OTWAY SHIRE

Project WYE RIVER AND SEPARATION CREEK STORMWATER MANAGEMENT SYSTEM

MANAGEMENT SYSTEM
DETAILED DESIGN PITS AND PIPES

Title WYE RIVER NORTH

DRAINAGE TYPICALS

SHEET 2 OF 4

POR TENDER ONLY
NOT TO BE USED FOR CONSTRUCTION PURPOSES

Datum Melways Ref. Scale Size
A.H.D X927,C9 AS SHOWN A1

Drawing Number Revision

V170115-CI-1101 2

COMPRESSIBLE MEMBRANE AROUND PIPES. (SEE NOTE 6)

- 1. BULKHEADS ARE REQUIRED FOR PIPES 300mm DIAMETER OR
- 2. BULKHEAD TO BE LOCATED DIRECTLY BEHIND DOWNSTREAM OF
- COLLAR SO AS NOT TO ENCASE THE JOINT 3. LOCATE BULKHEAD AT A RETAINING WALL UNDER THE WALL.
- 4. KEY CONCRETE BULKHEADS INTO SIDES AND BOTTOM OF TRENCH AGAINST A BEARING SURFACE OF UNDISTURBED SOIL
- CONCRETE TO BE CLASS N25
- DO NOT DEFORM PIPES DURING PLACEMENT OF CONCRETE PROVIDE CONTINUOUS DRAINAGE PATH THROUGH BULKHEADS
- 8. COMPRESSIBLE MEMBRANE AROUND PIPE TO BE 3 THICK RUBBER FOR
- BULKHEADS ON SLOPES

- PIPE BEDDING AND BACKFILL


REQUIREMENTS. REFER TO


SUBJECT TO TRENCHING

PIPE TRENCH DETAILS


- 9. GROUNDWATER DRAIN THROUGH BULKHEAD IS NOT REQUIRED
- WHEREVER BACKFILL IS CEMENT TREATED 10. GROUNDWATER DRAINS THROUGH BULKHEADS SHALL BE FILLED WITH
- FIBREGLASS WOOL OR OTHER APPROVED FILTER MATERIAL 11. BULKHEADS SHALL BE CONSTRUCTED AT EVERY SECOND JOINT WHERE PIPE GRADES EXCEED 15% (1 in 6.7) AND CEMENT TREATED

BACKFILL IS NOT SPECIFIED. REFER TYPICAL DETAIL

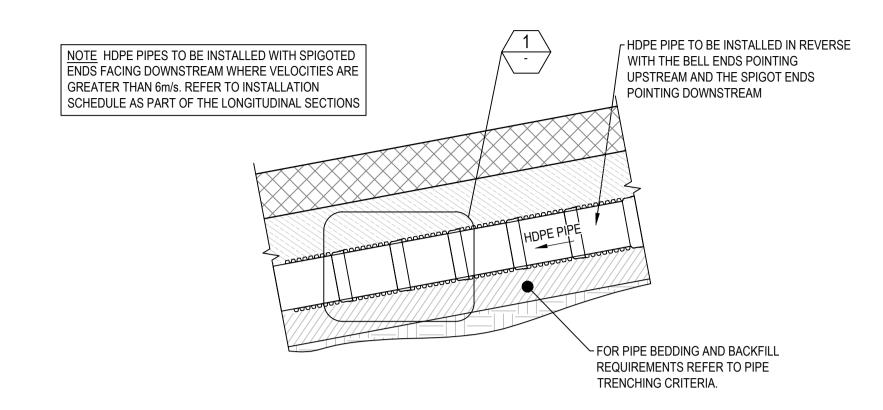

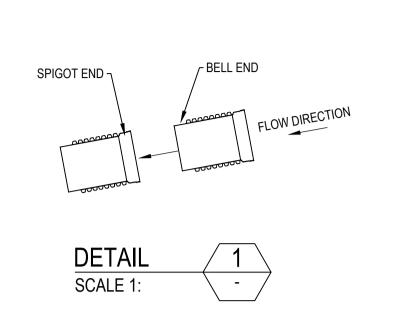


HIGH VELOCITY HDPE PIPE INSTALLATION DETAIL NOT TO SCALE

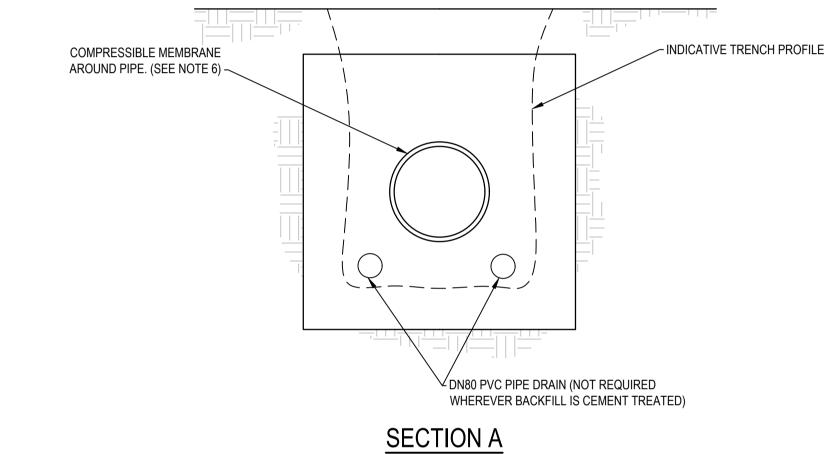



CONCRETE BULKHEAD FOR RCP DETAIL
NOT TO SCALE


15% > PIPE GRADE > 50%

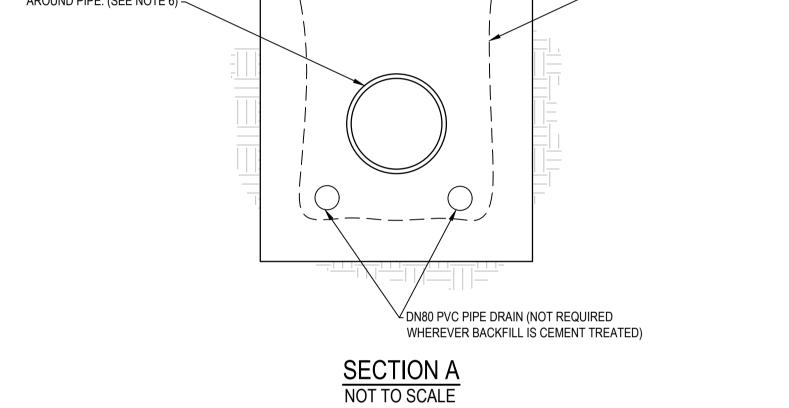

PLANT SCHEDULE FOR SLOPES STEEPER THAN 1 IN 2				
BOTANICAL NAME	COMMON NAME	PLANT DENSITY	NOTES	
GOODENIA OVATA	HOP GOODENIA	1 -2 PLANTS PER 50m2	DISPERSED PLANTING AND PLANT AT TOP OF BANKS/TRANSITION BETWEEN ROAD AND PIPE TRENCH	
CORREA ALBA	WHITE CORREA	1 -2 PLANTS PER 50m2	DISPERSED PLANTING AND IMMEDIATELY UPSTREAM OF PITS	
POA POAFORMIS	COAST TUSSOCK-GRASS	5 PLANTS PER 5m2	PLANT IN CLUMPS OF 5	
LOMANDRA LONGFOLIA	MAT RUSH	1 -2 PLANTS PER 50m2	DISPERSED PLANTING	
ENCHYLAENA TOMENTOSA	RUBY SALTBUSH	1 -2 PLANTS PER 50m2	DISPERSED PLANTING	
MICROLAENA STIPOIDES	WEEPING GRASS	10g/m2	BEGIN WITH A WEED FREE SEED BED. SOW SEED 10-15mm BELOW THE SOIL SURFACE	

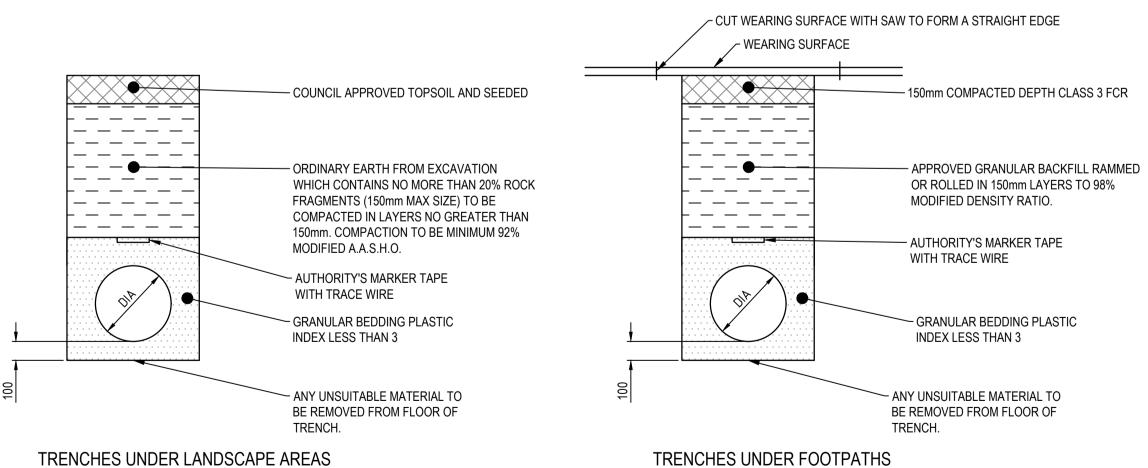

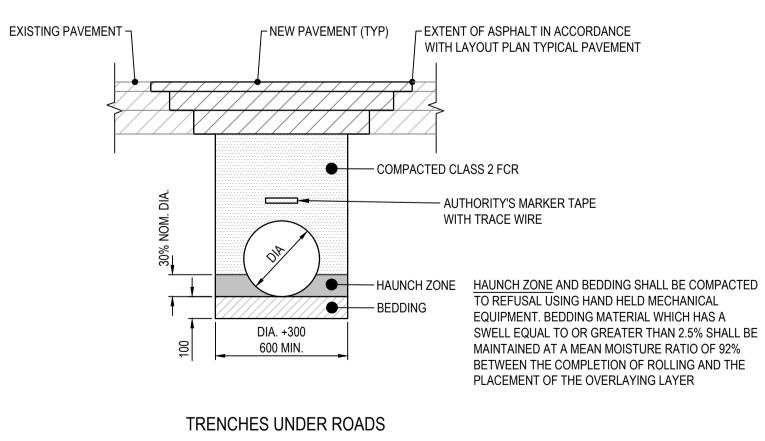

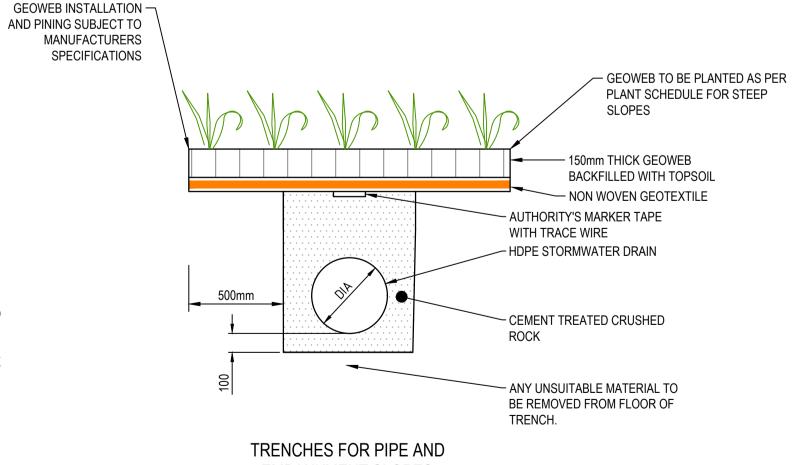

PIPE TRENCH DETAILS NOT TO SCALE

EMBANKMENT SLOPES STEEPER THAN 1 IN 2

WARNING EXTERNAL APPROVAL THIS DRAWING IS SUBJECT TO THE APPROVAL OF COLAC OTWAY SHIRE AND IS A PRELIMINARY ISSUE

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<i>F</i>	E.H	18/10/2017
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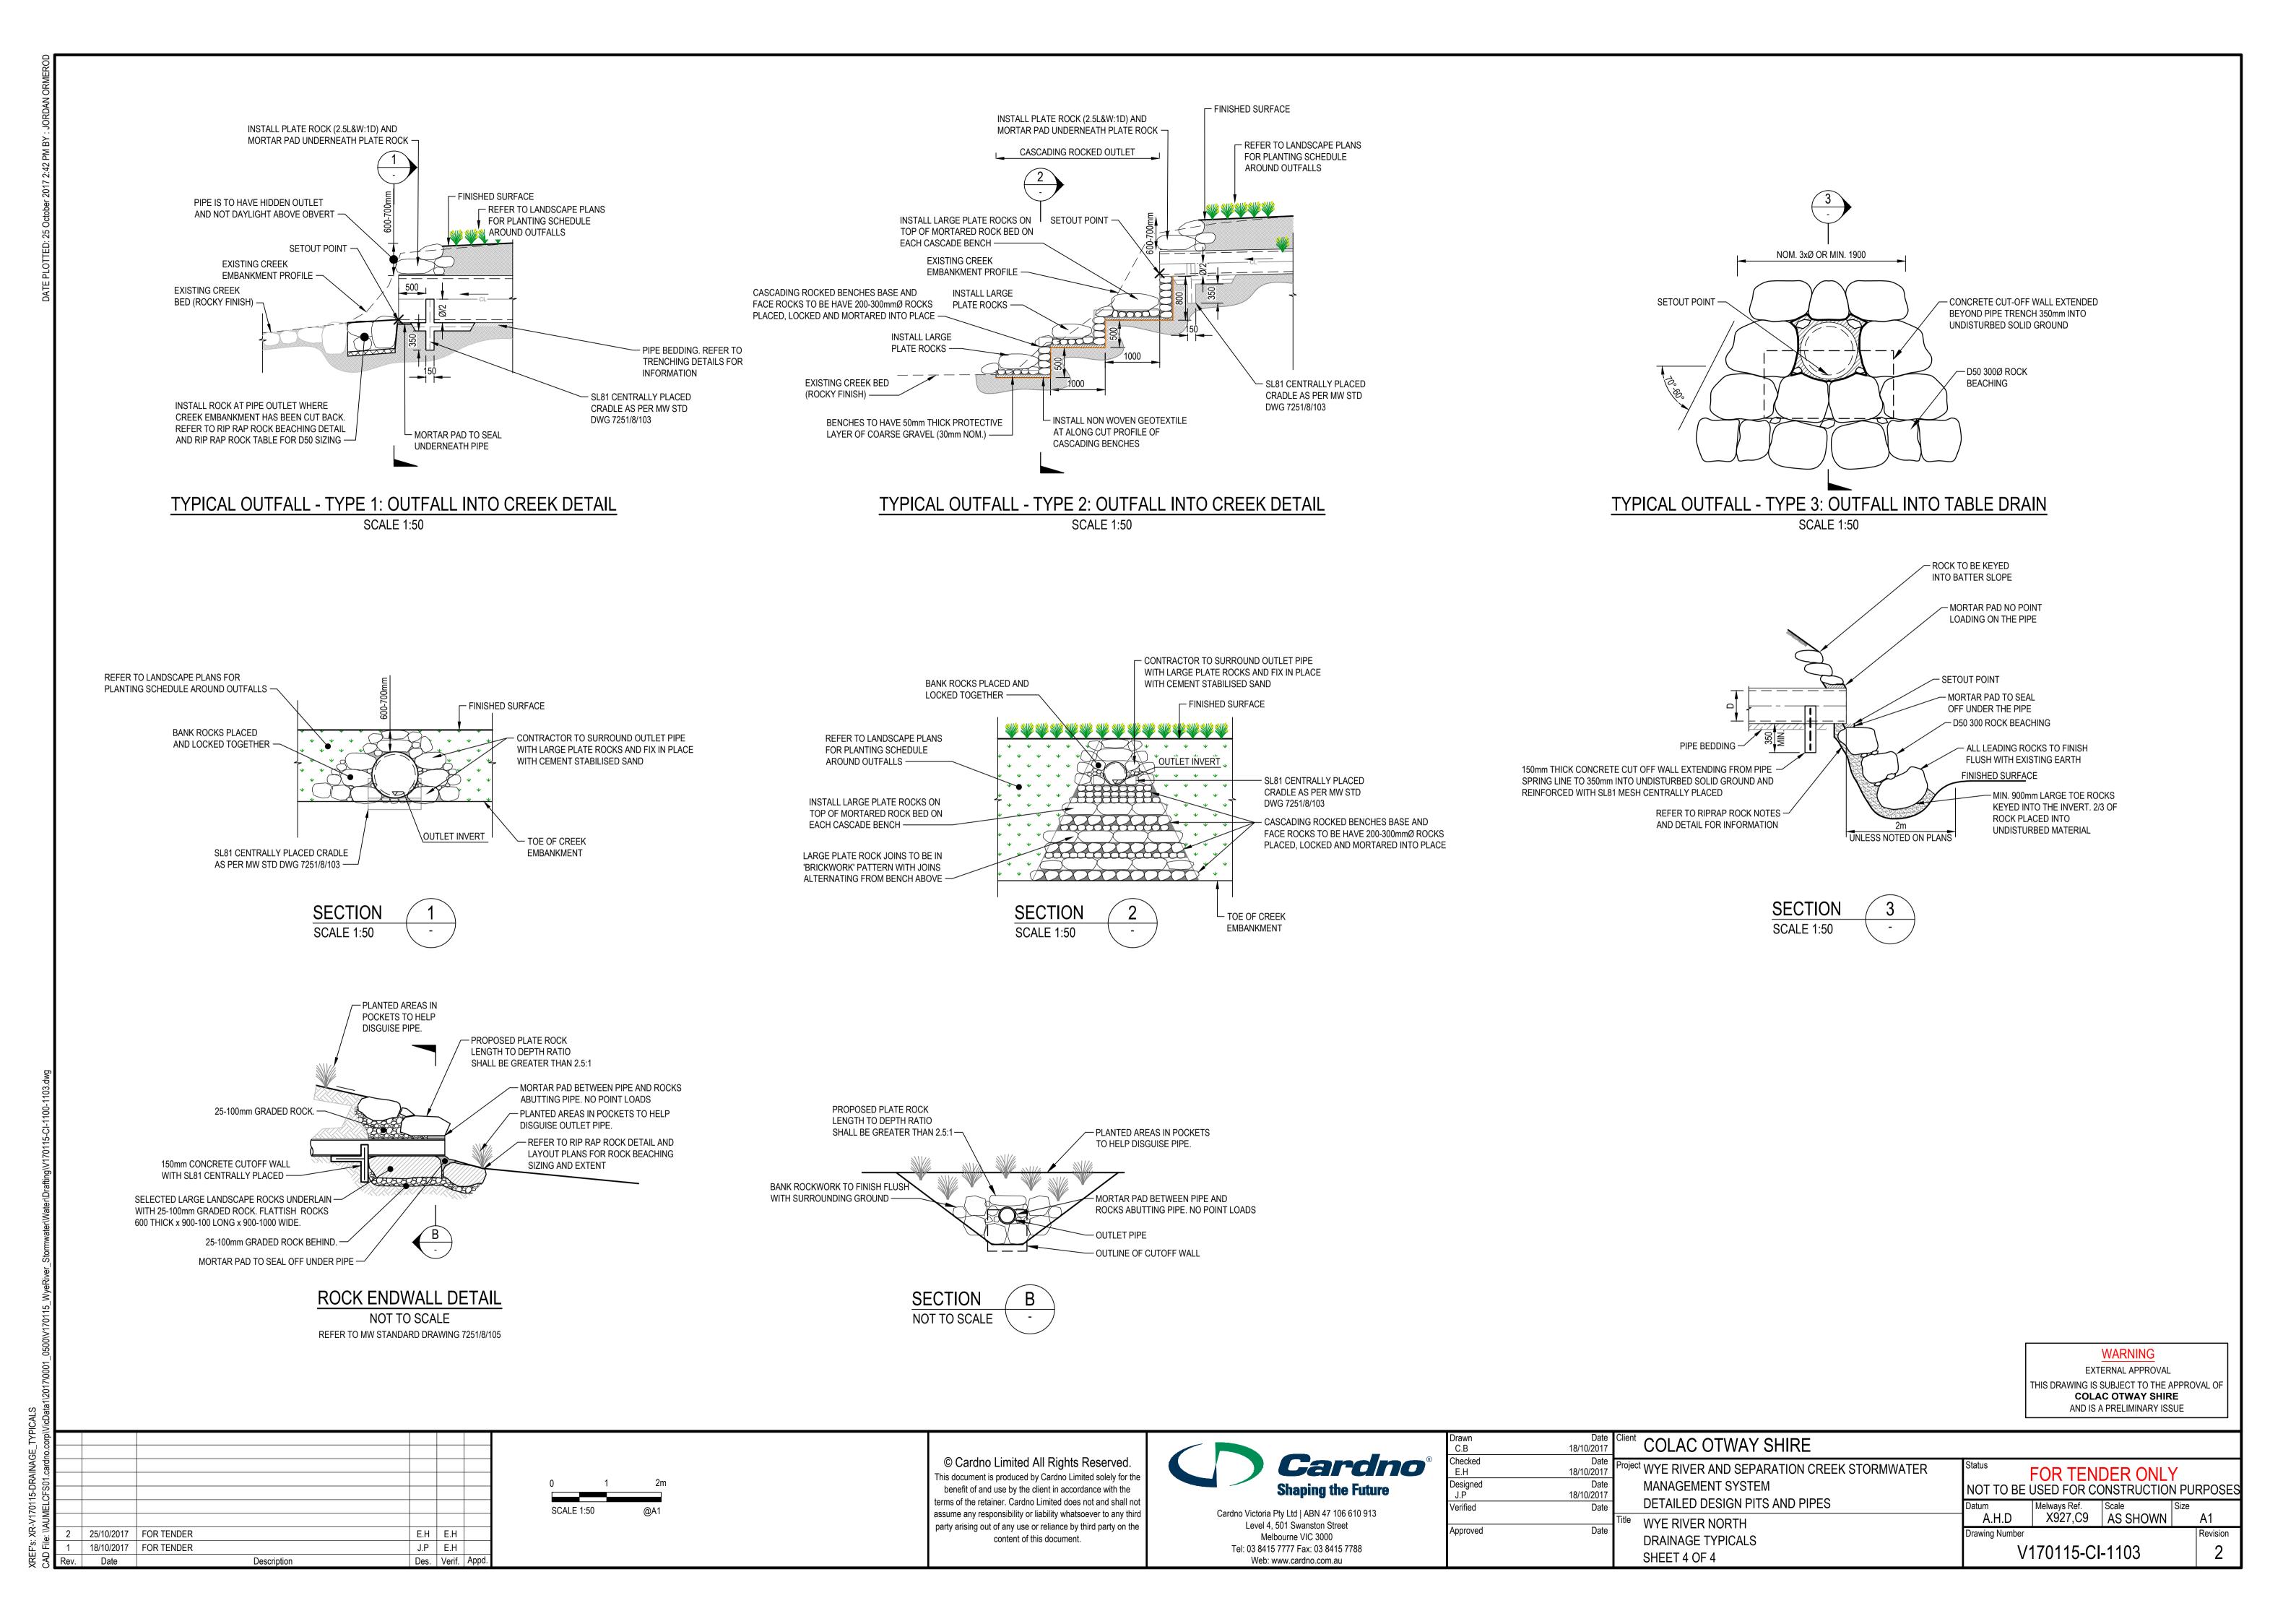
Client	COLAC OTWAY SHIRE
Project	WYE RIVER AND SEPARATION CREEK STORMWATER
	MANAGEMENT SYSTEM
	DETAILED DESIGN PITS AND PIPES
Title	WYE RIVER NORTH


DRAINAGE TYPICALS


SHEET 3 OF 4


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Drawing Number				Revision


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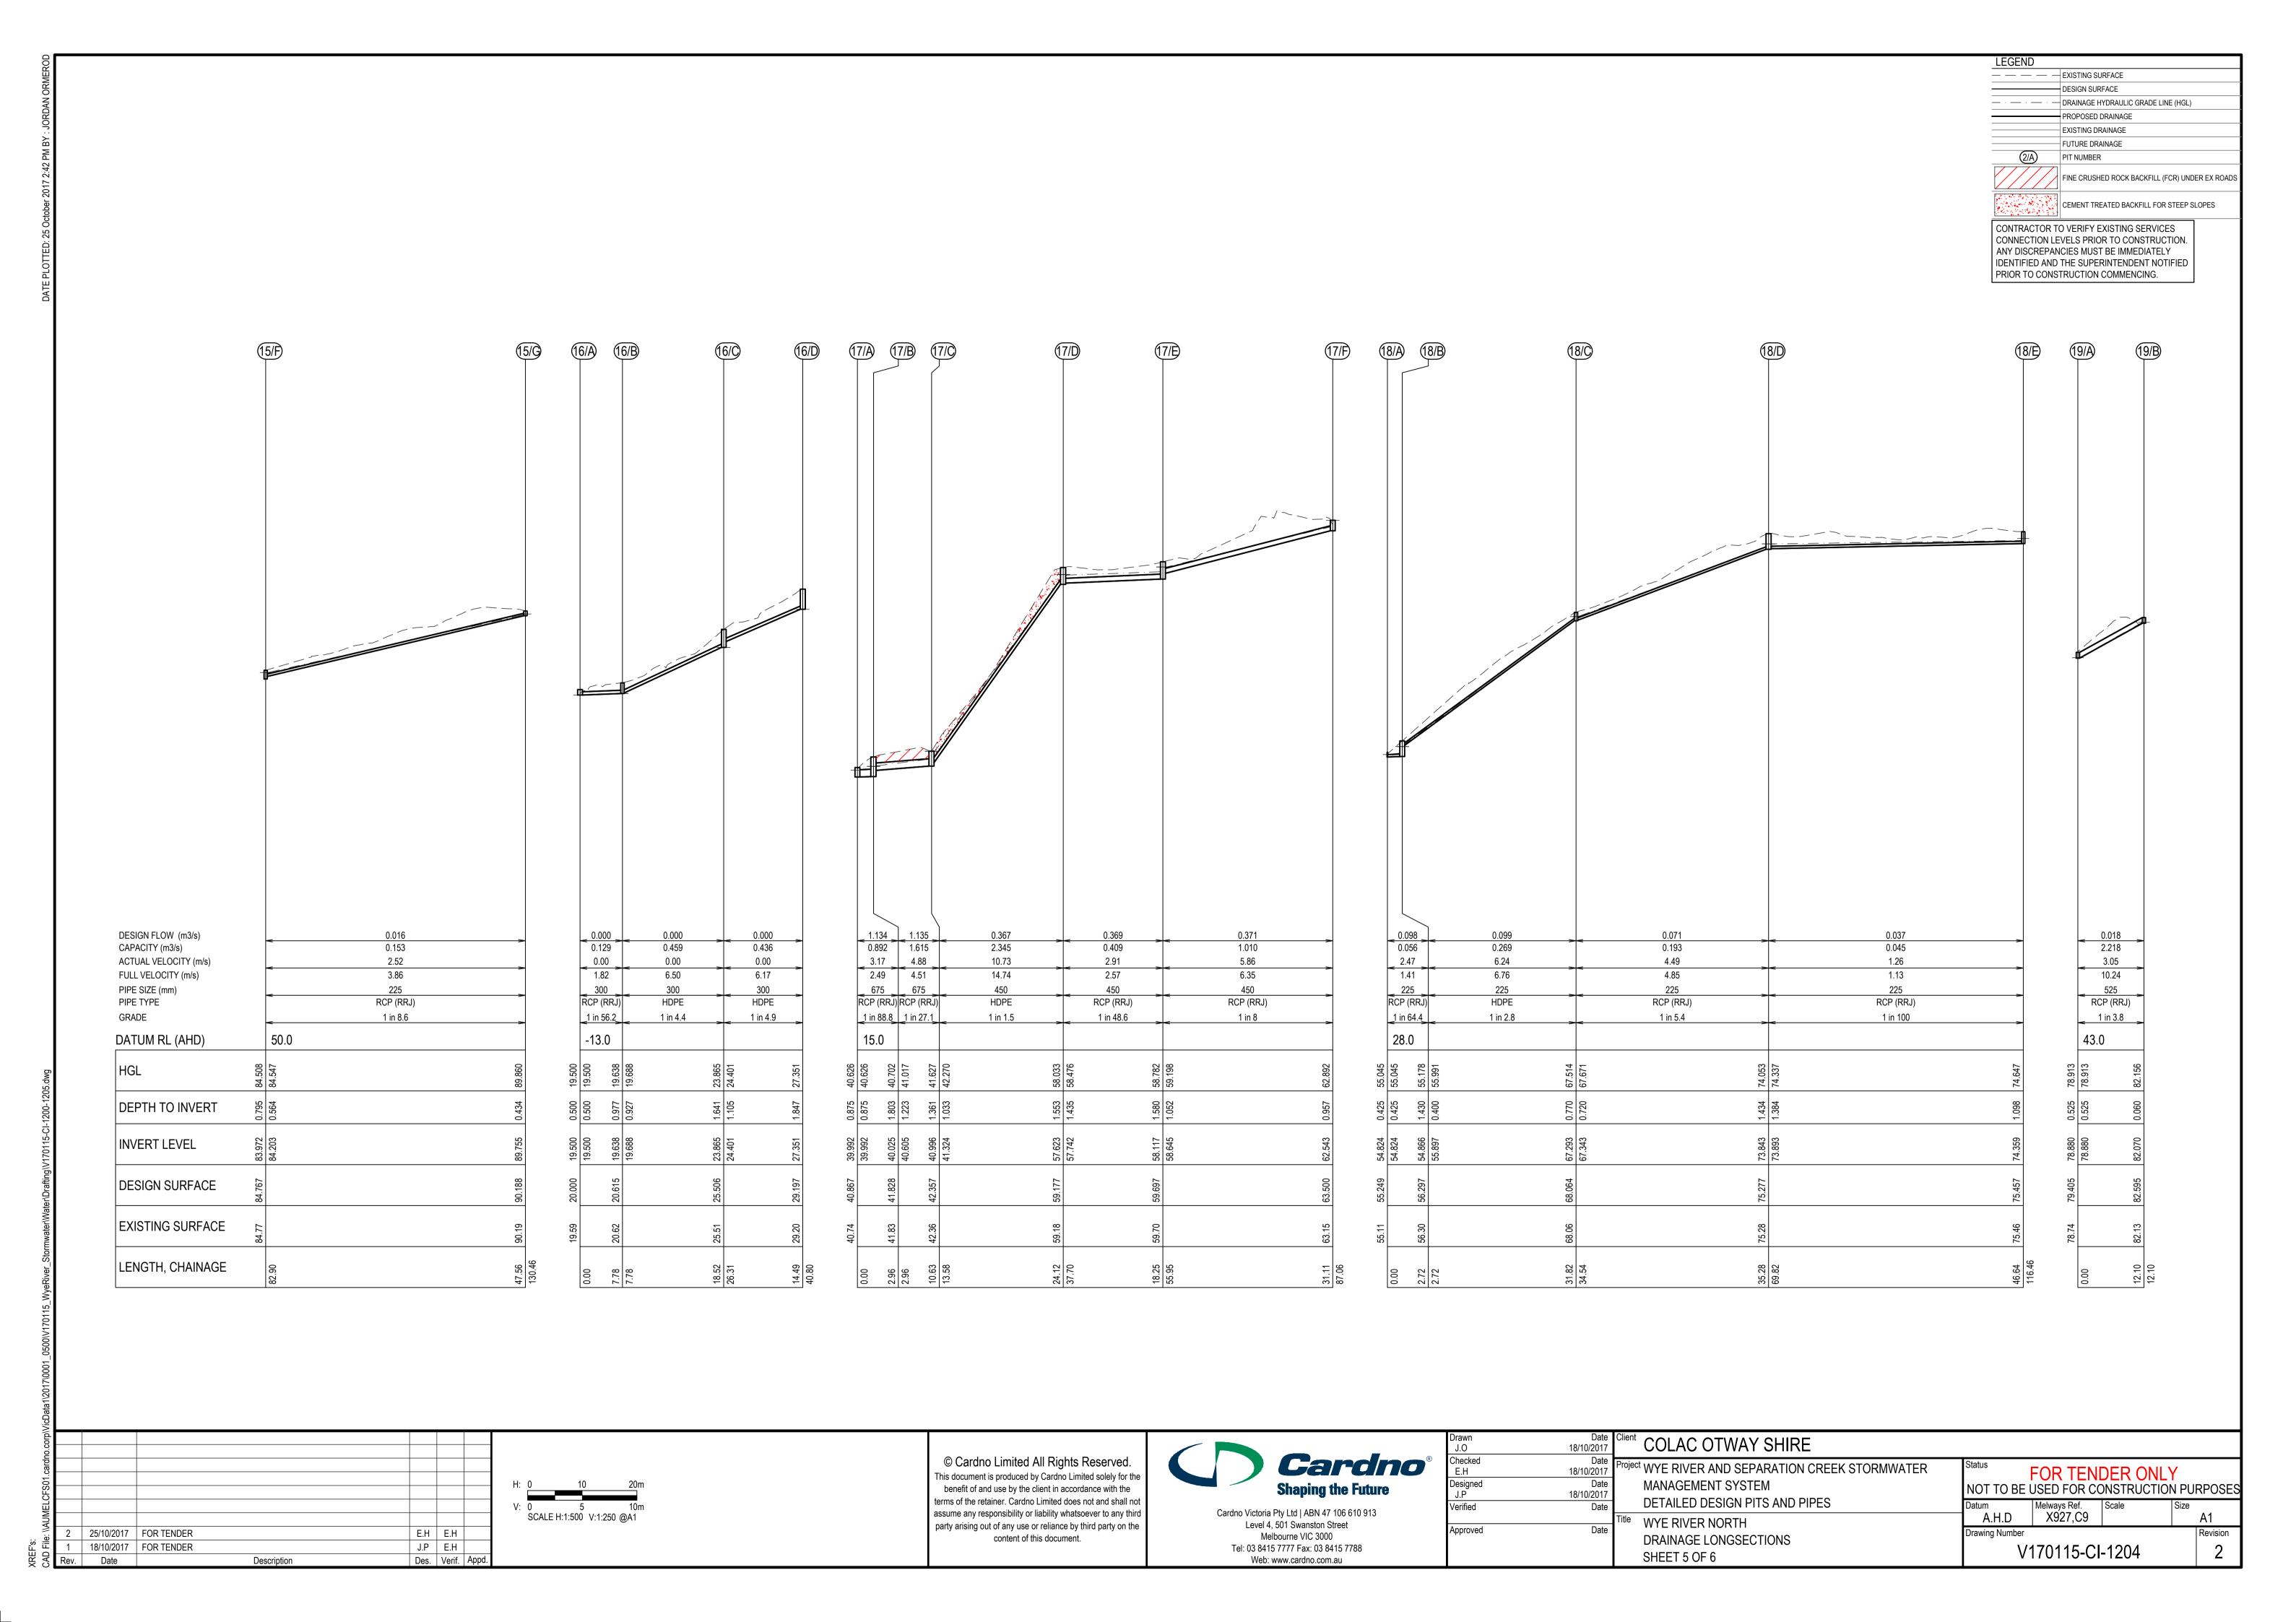




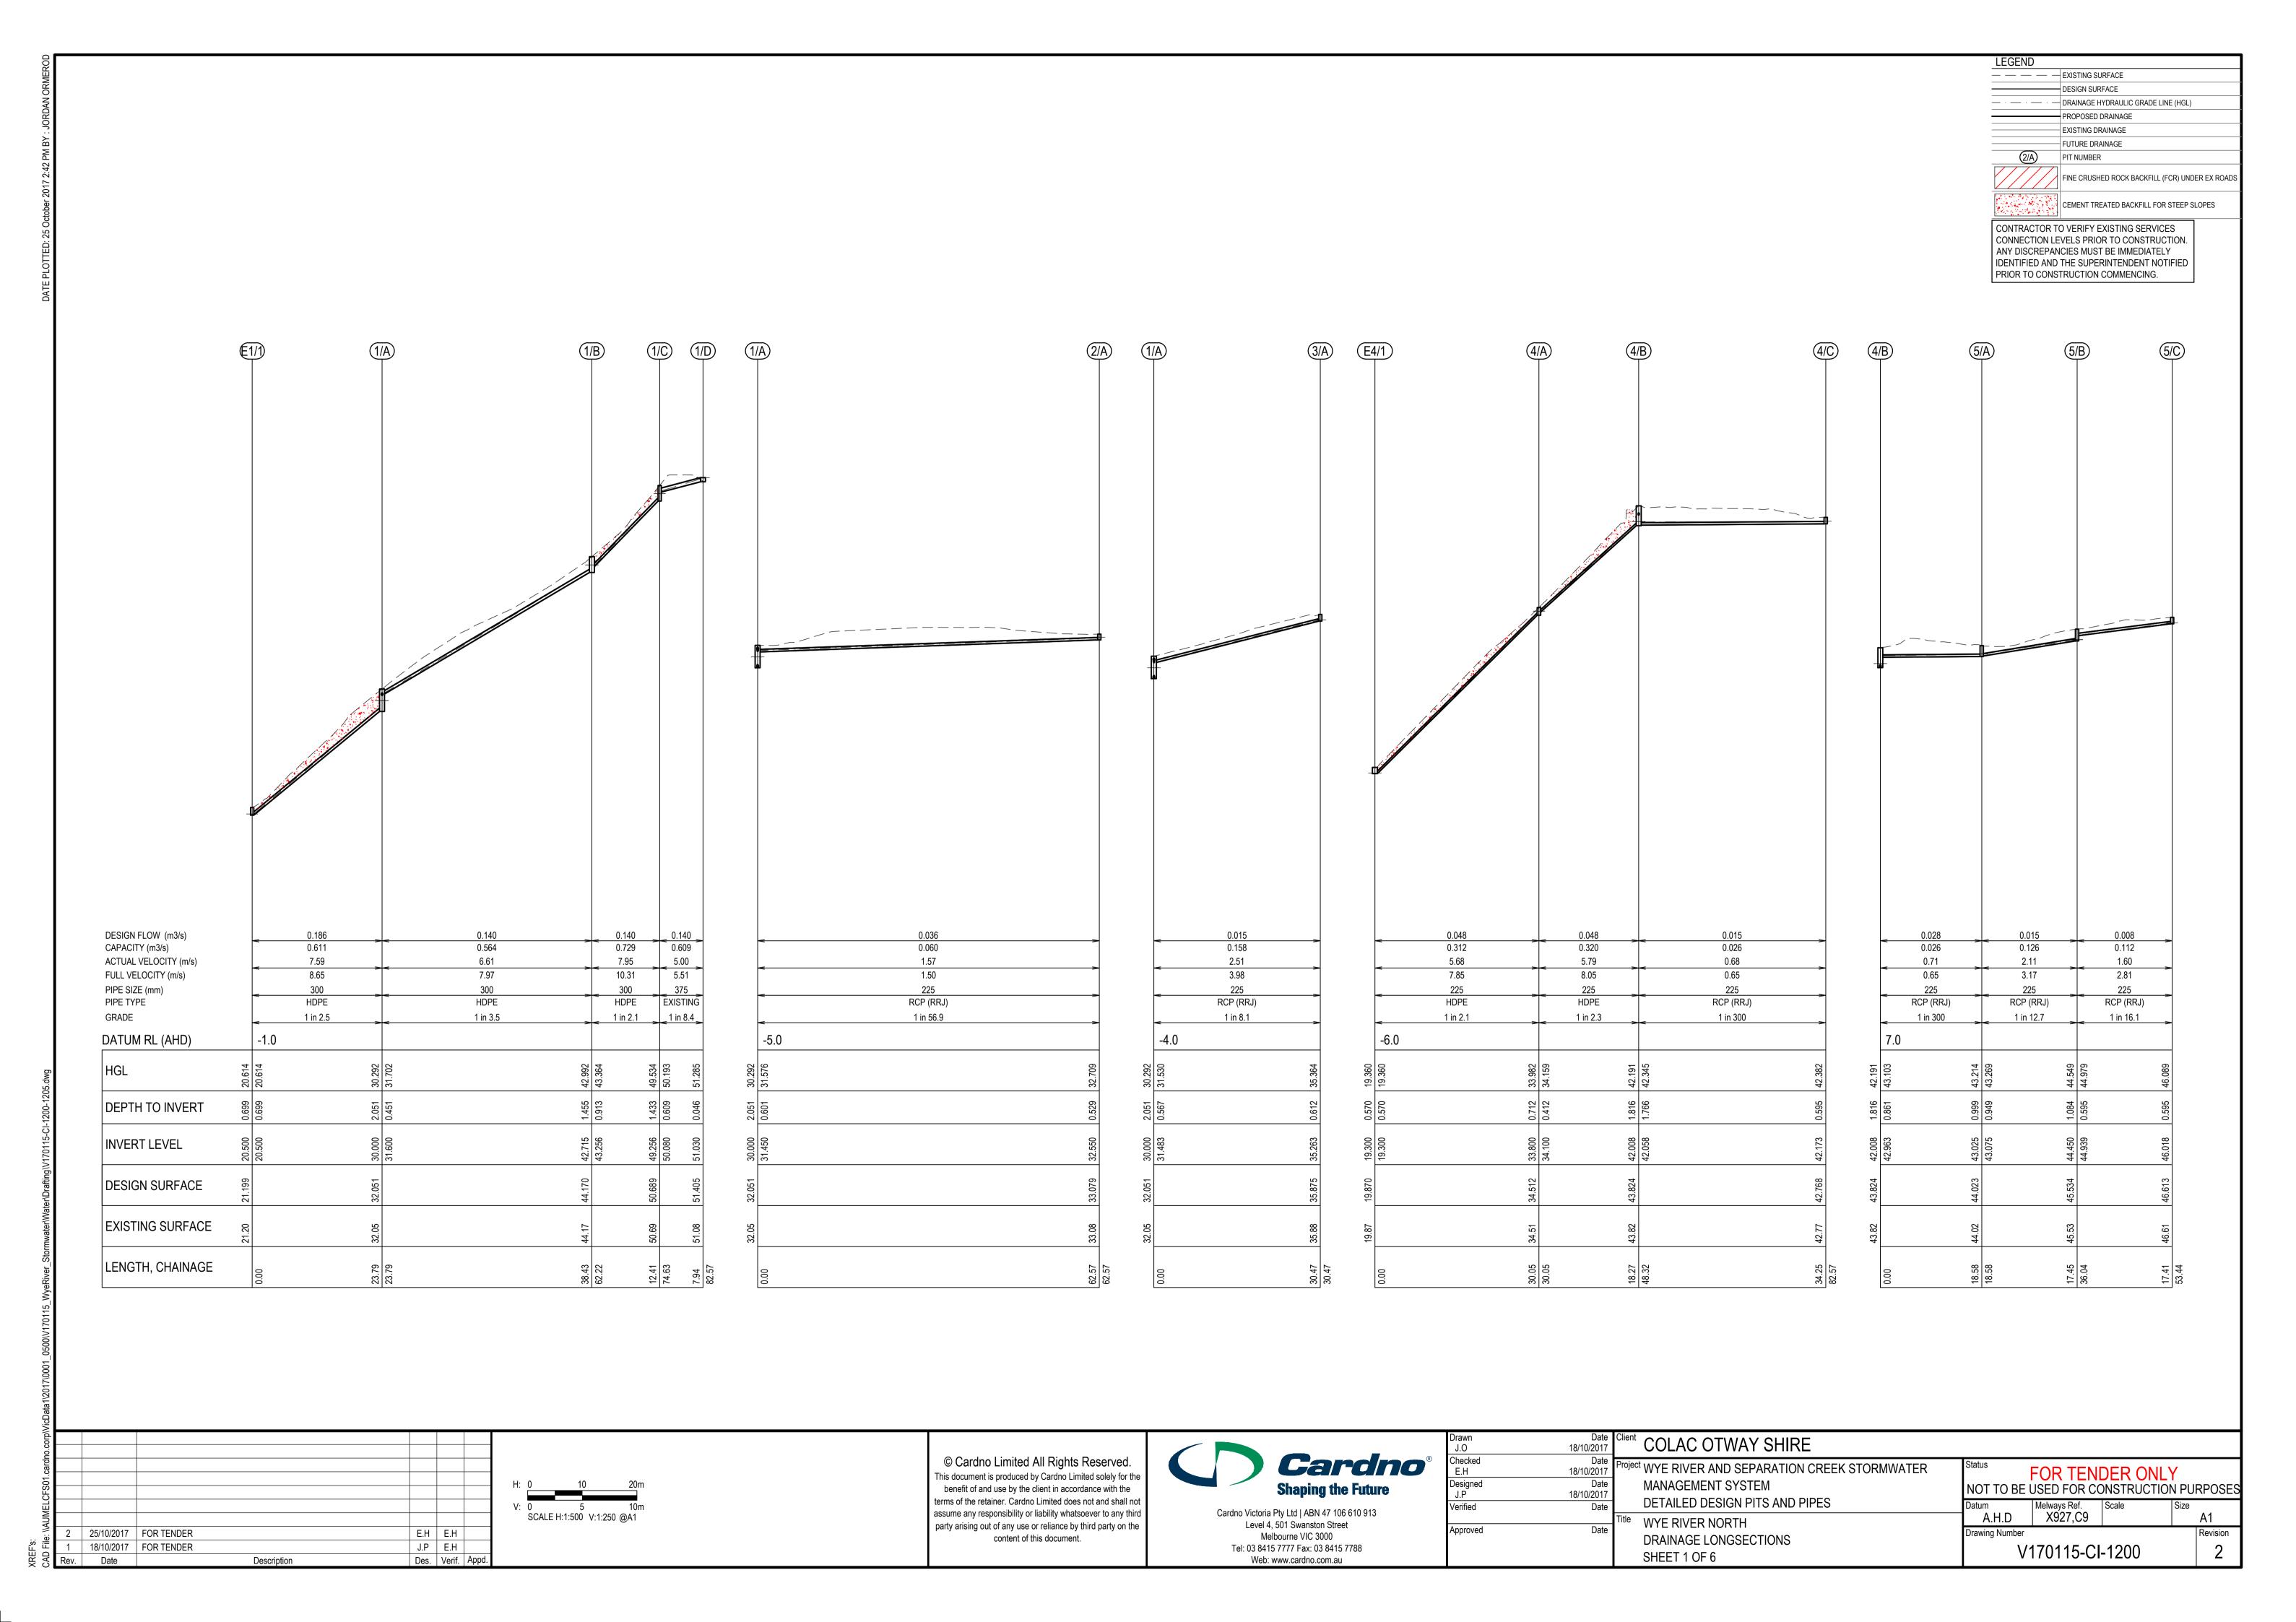

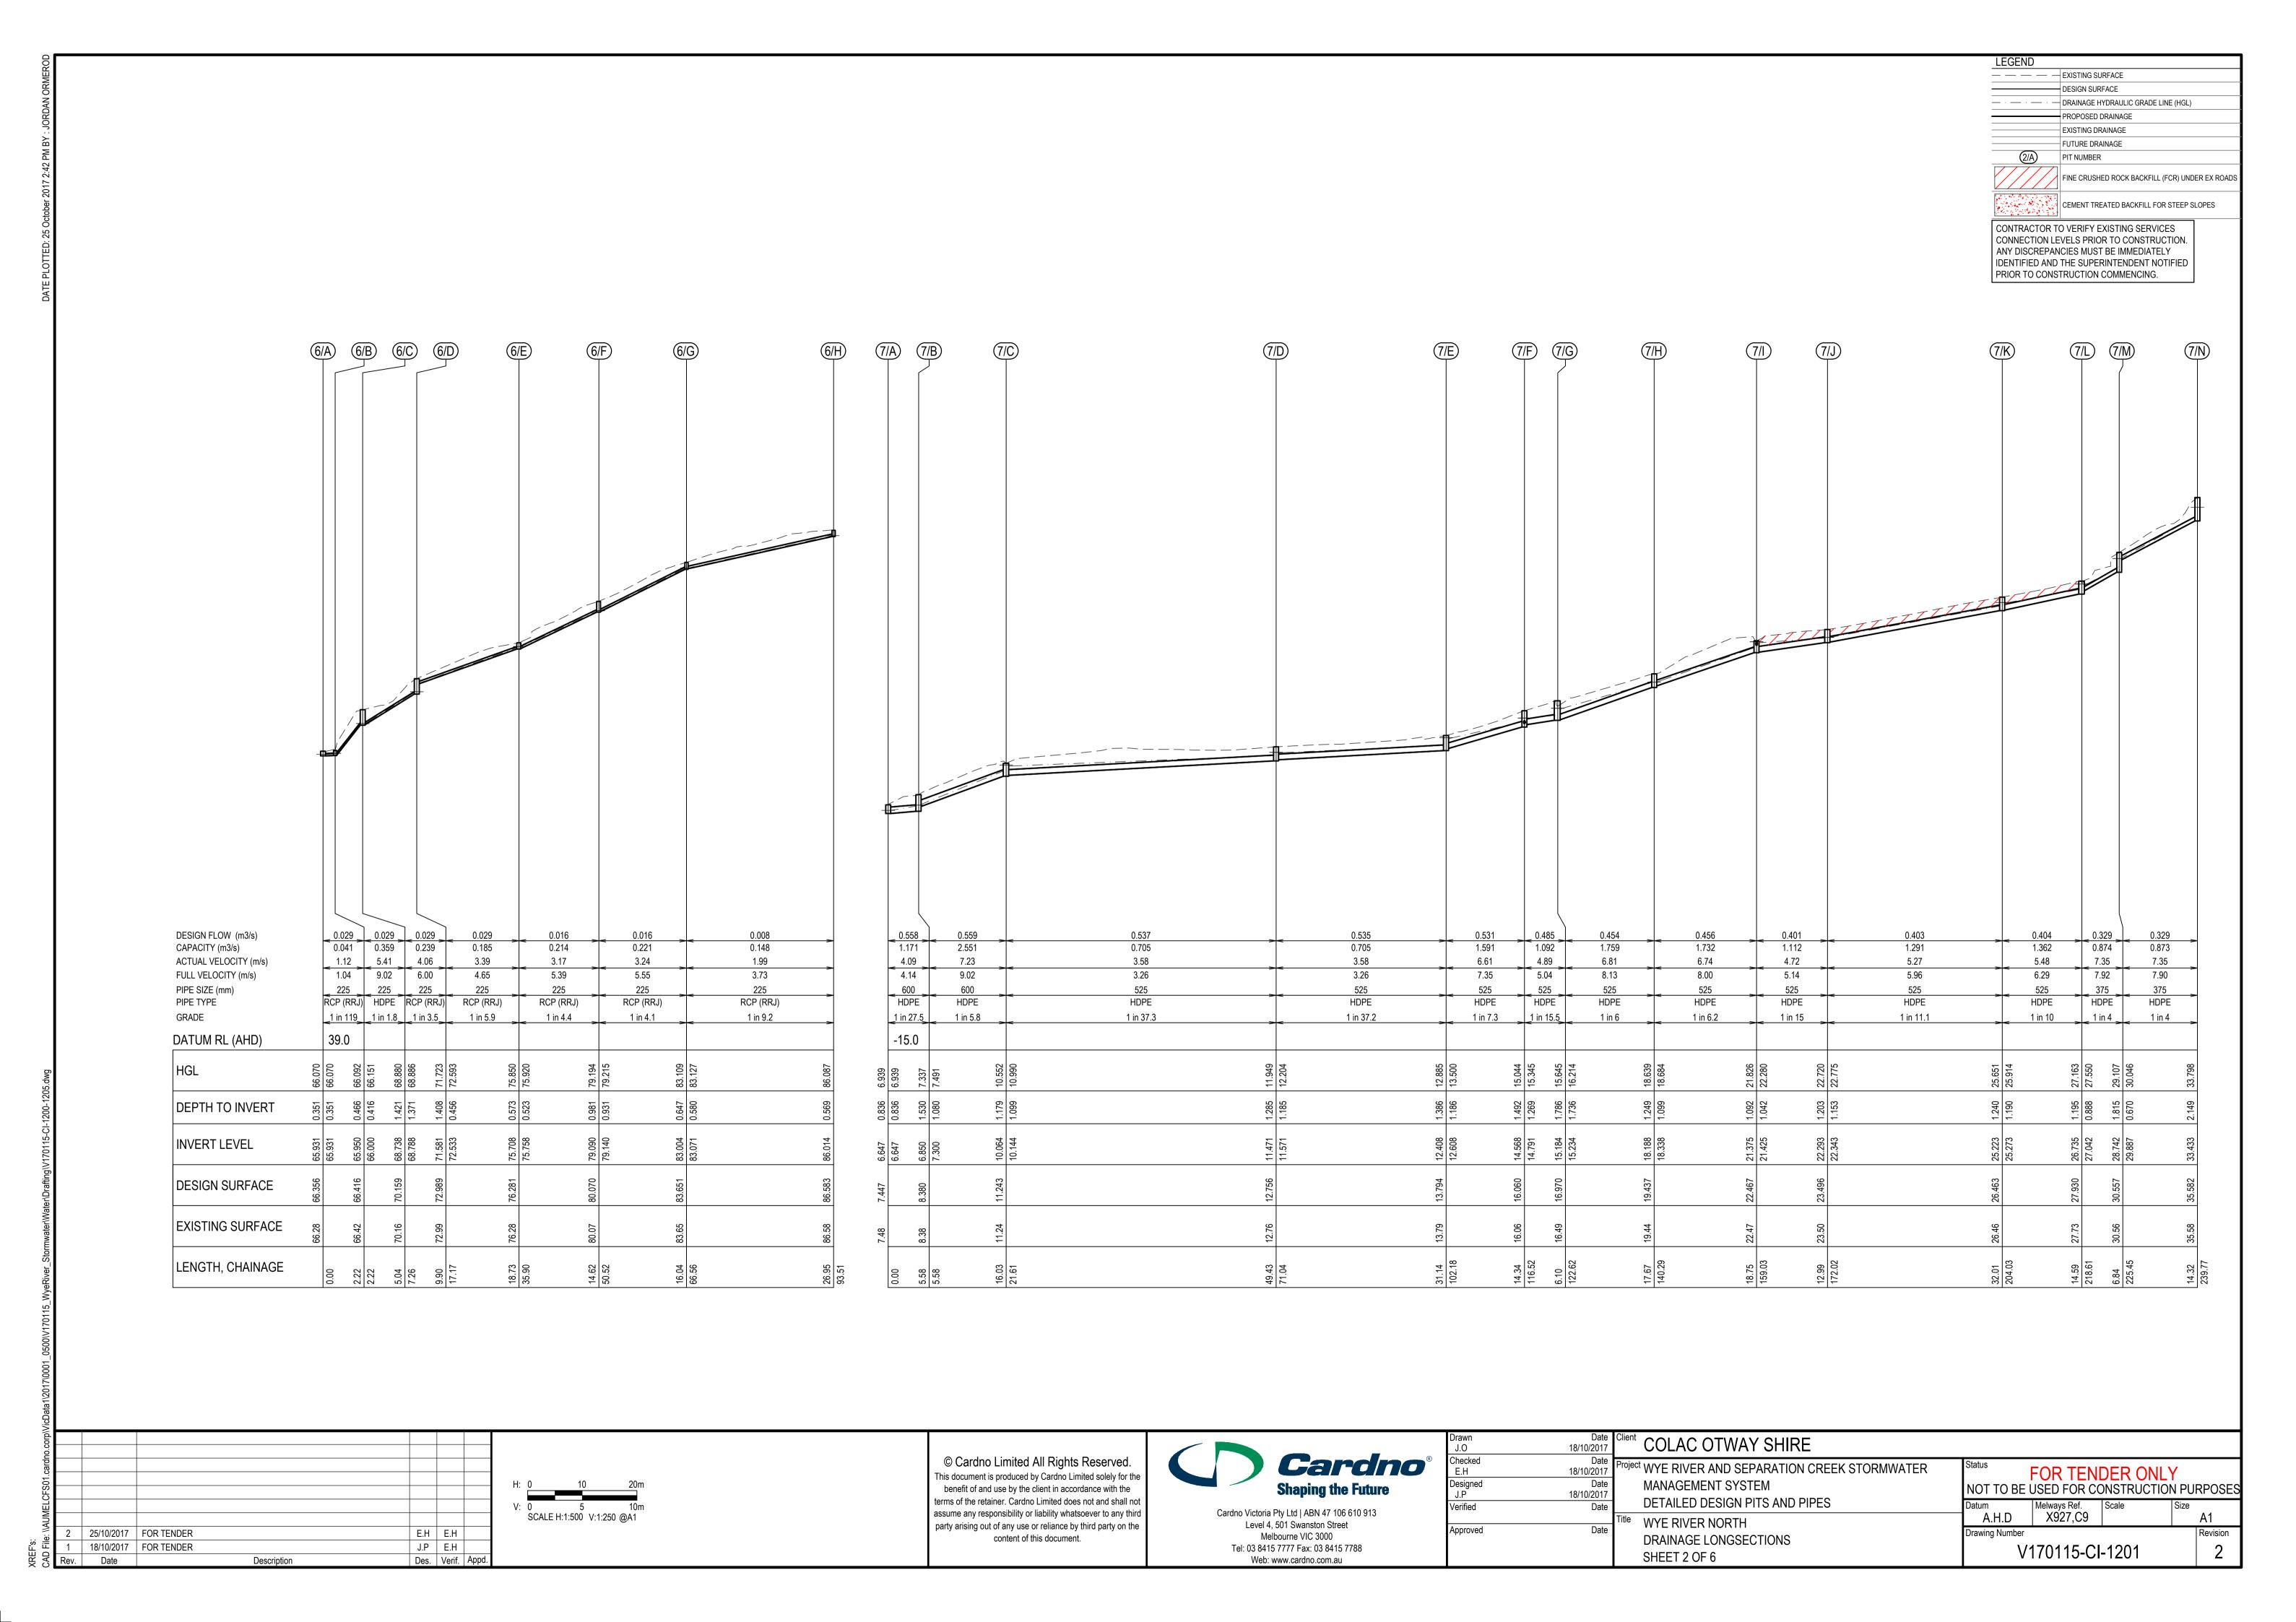

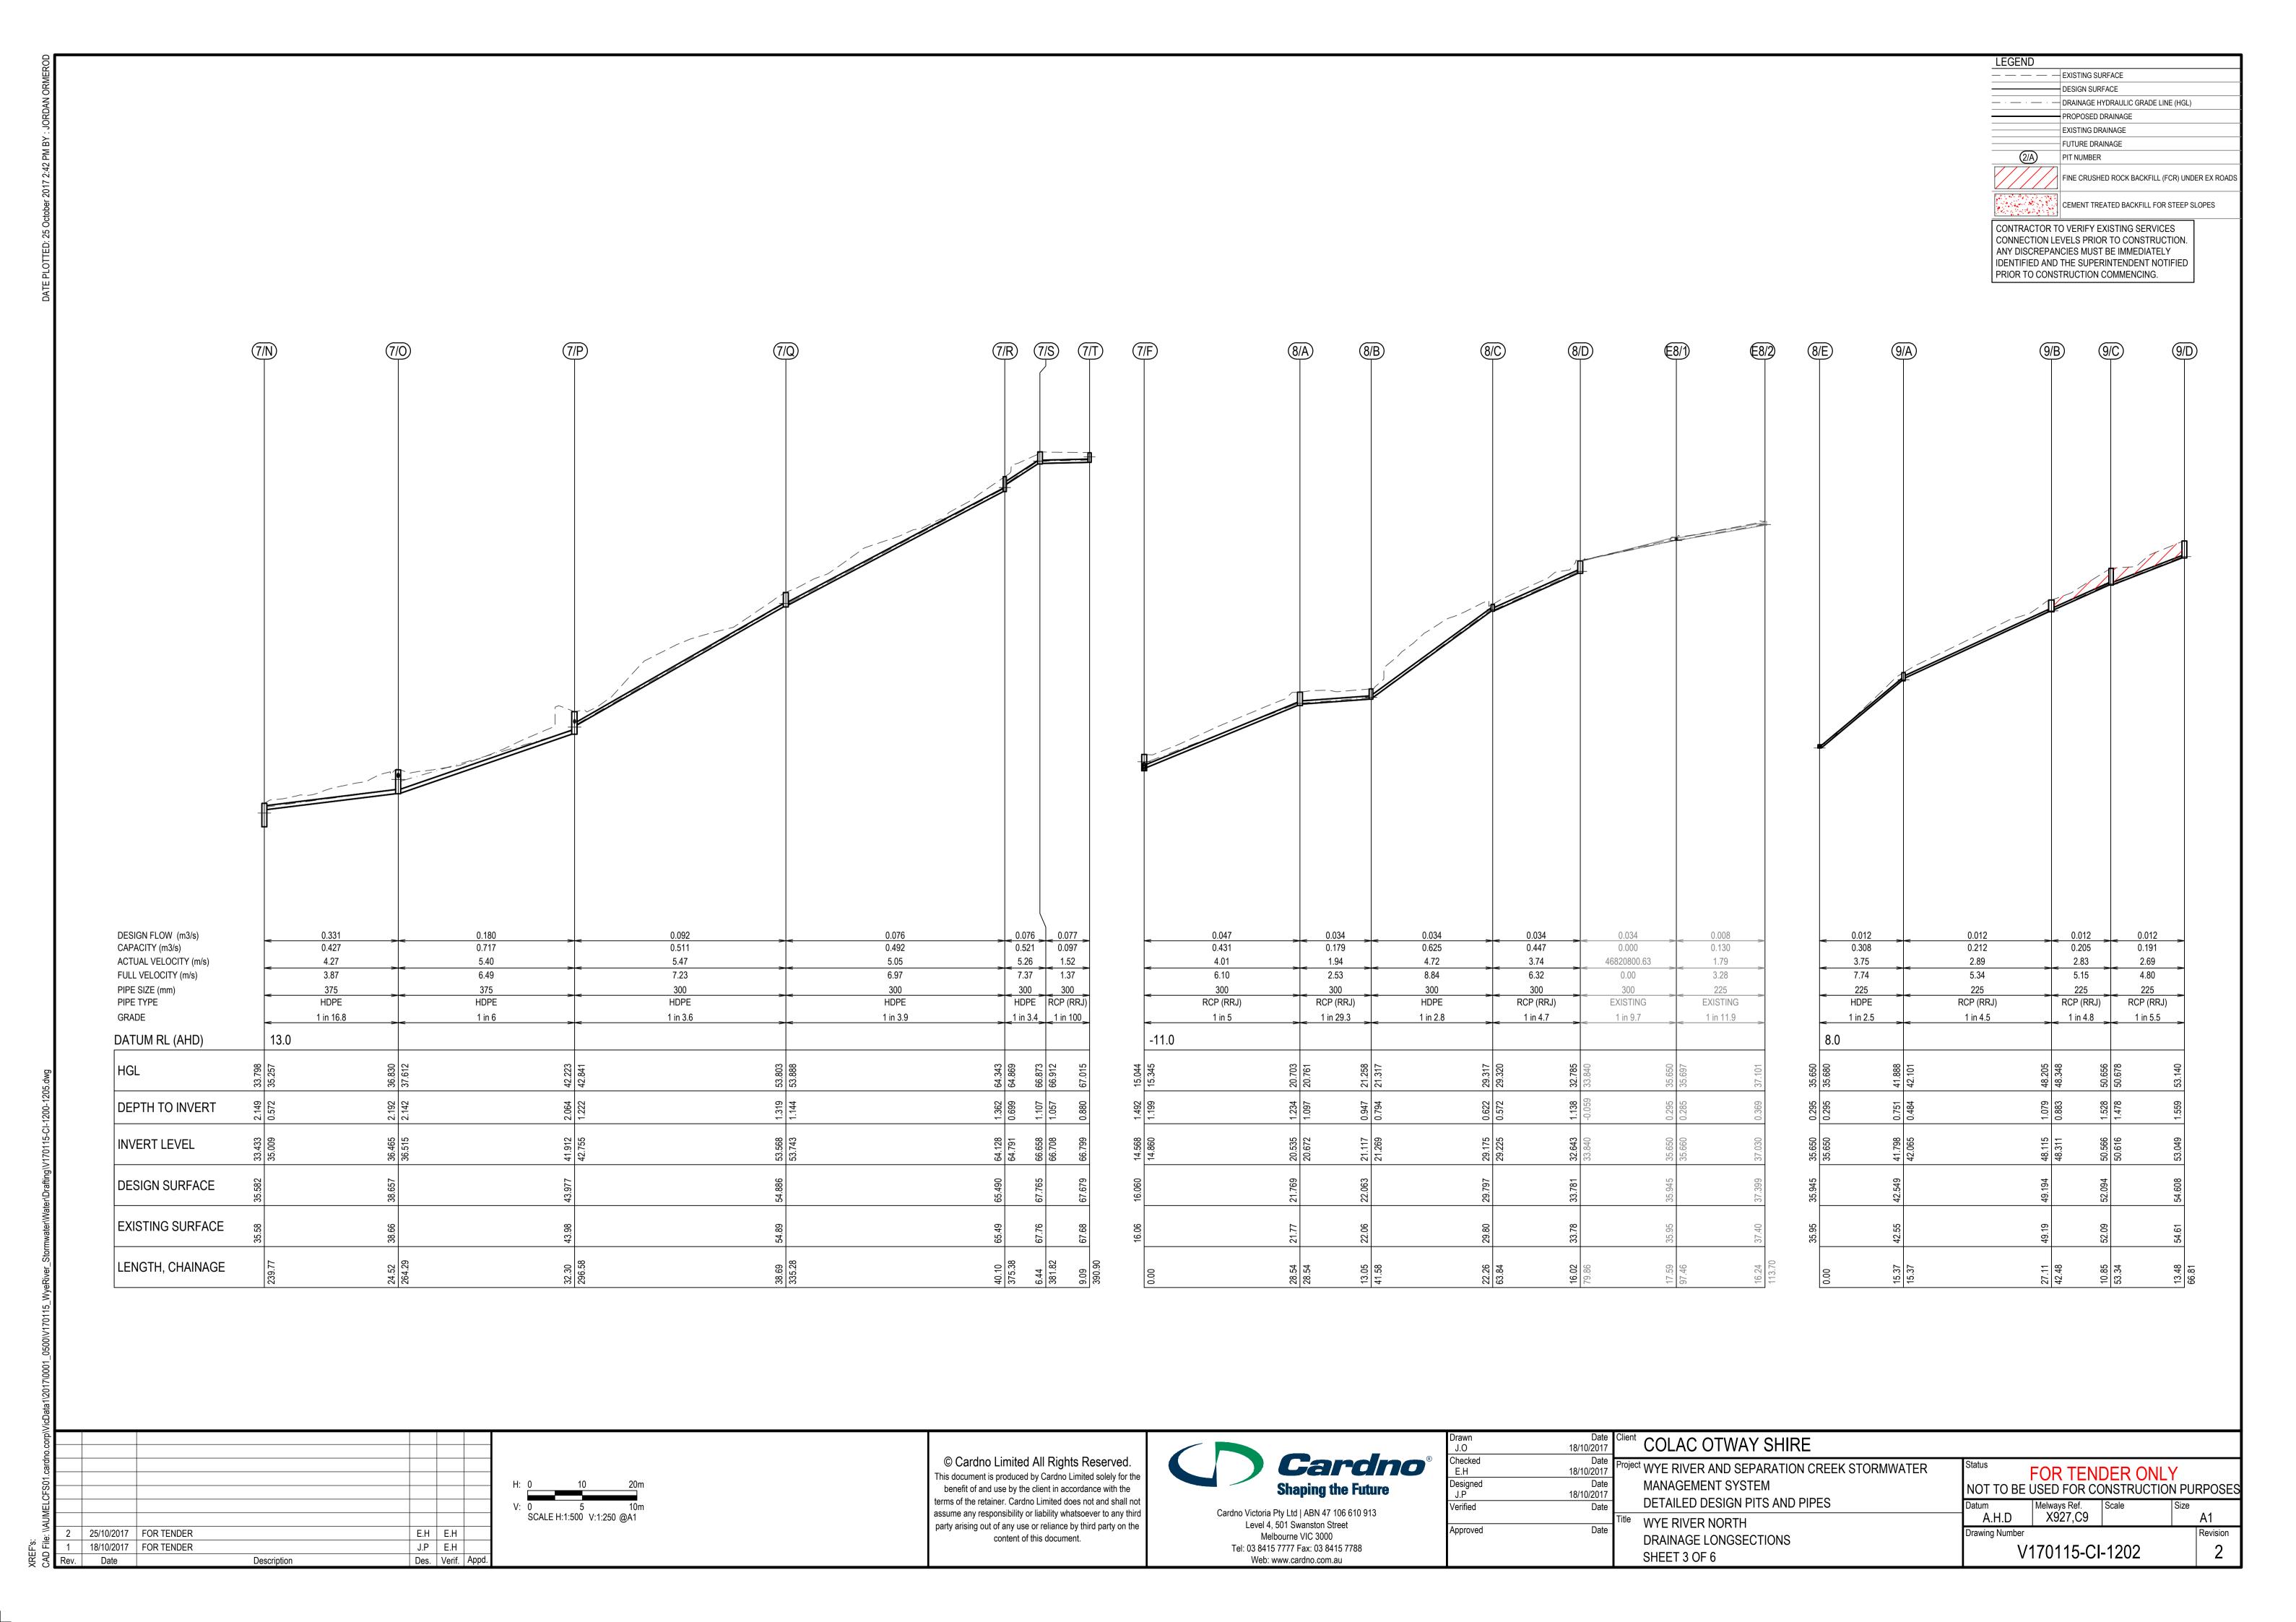

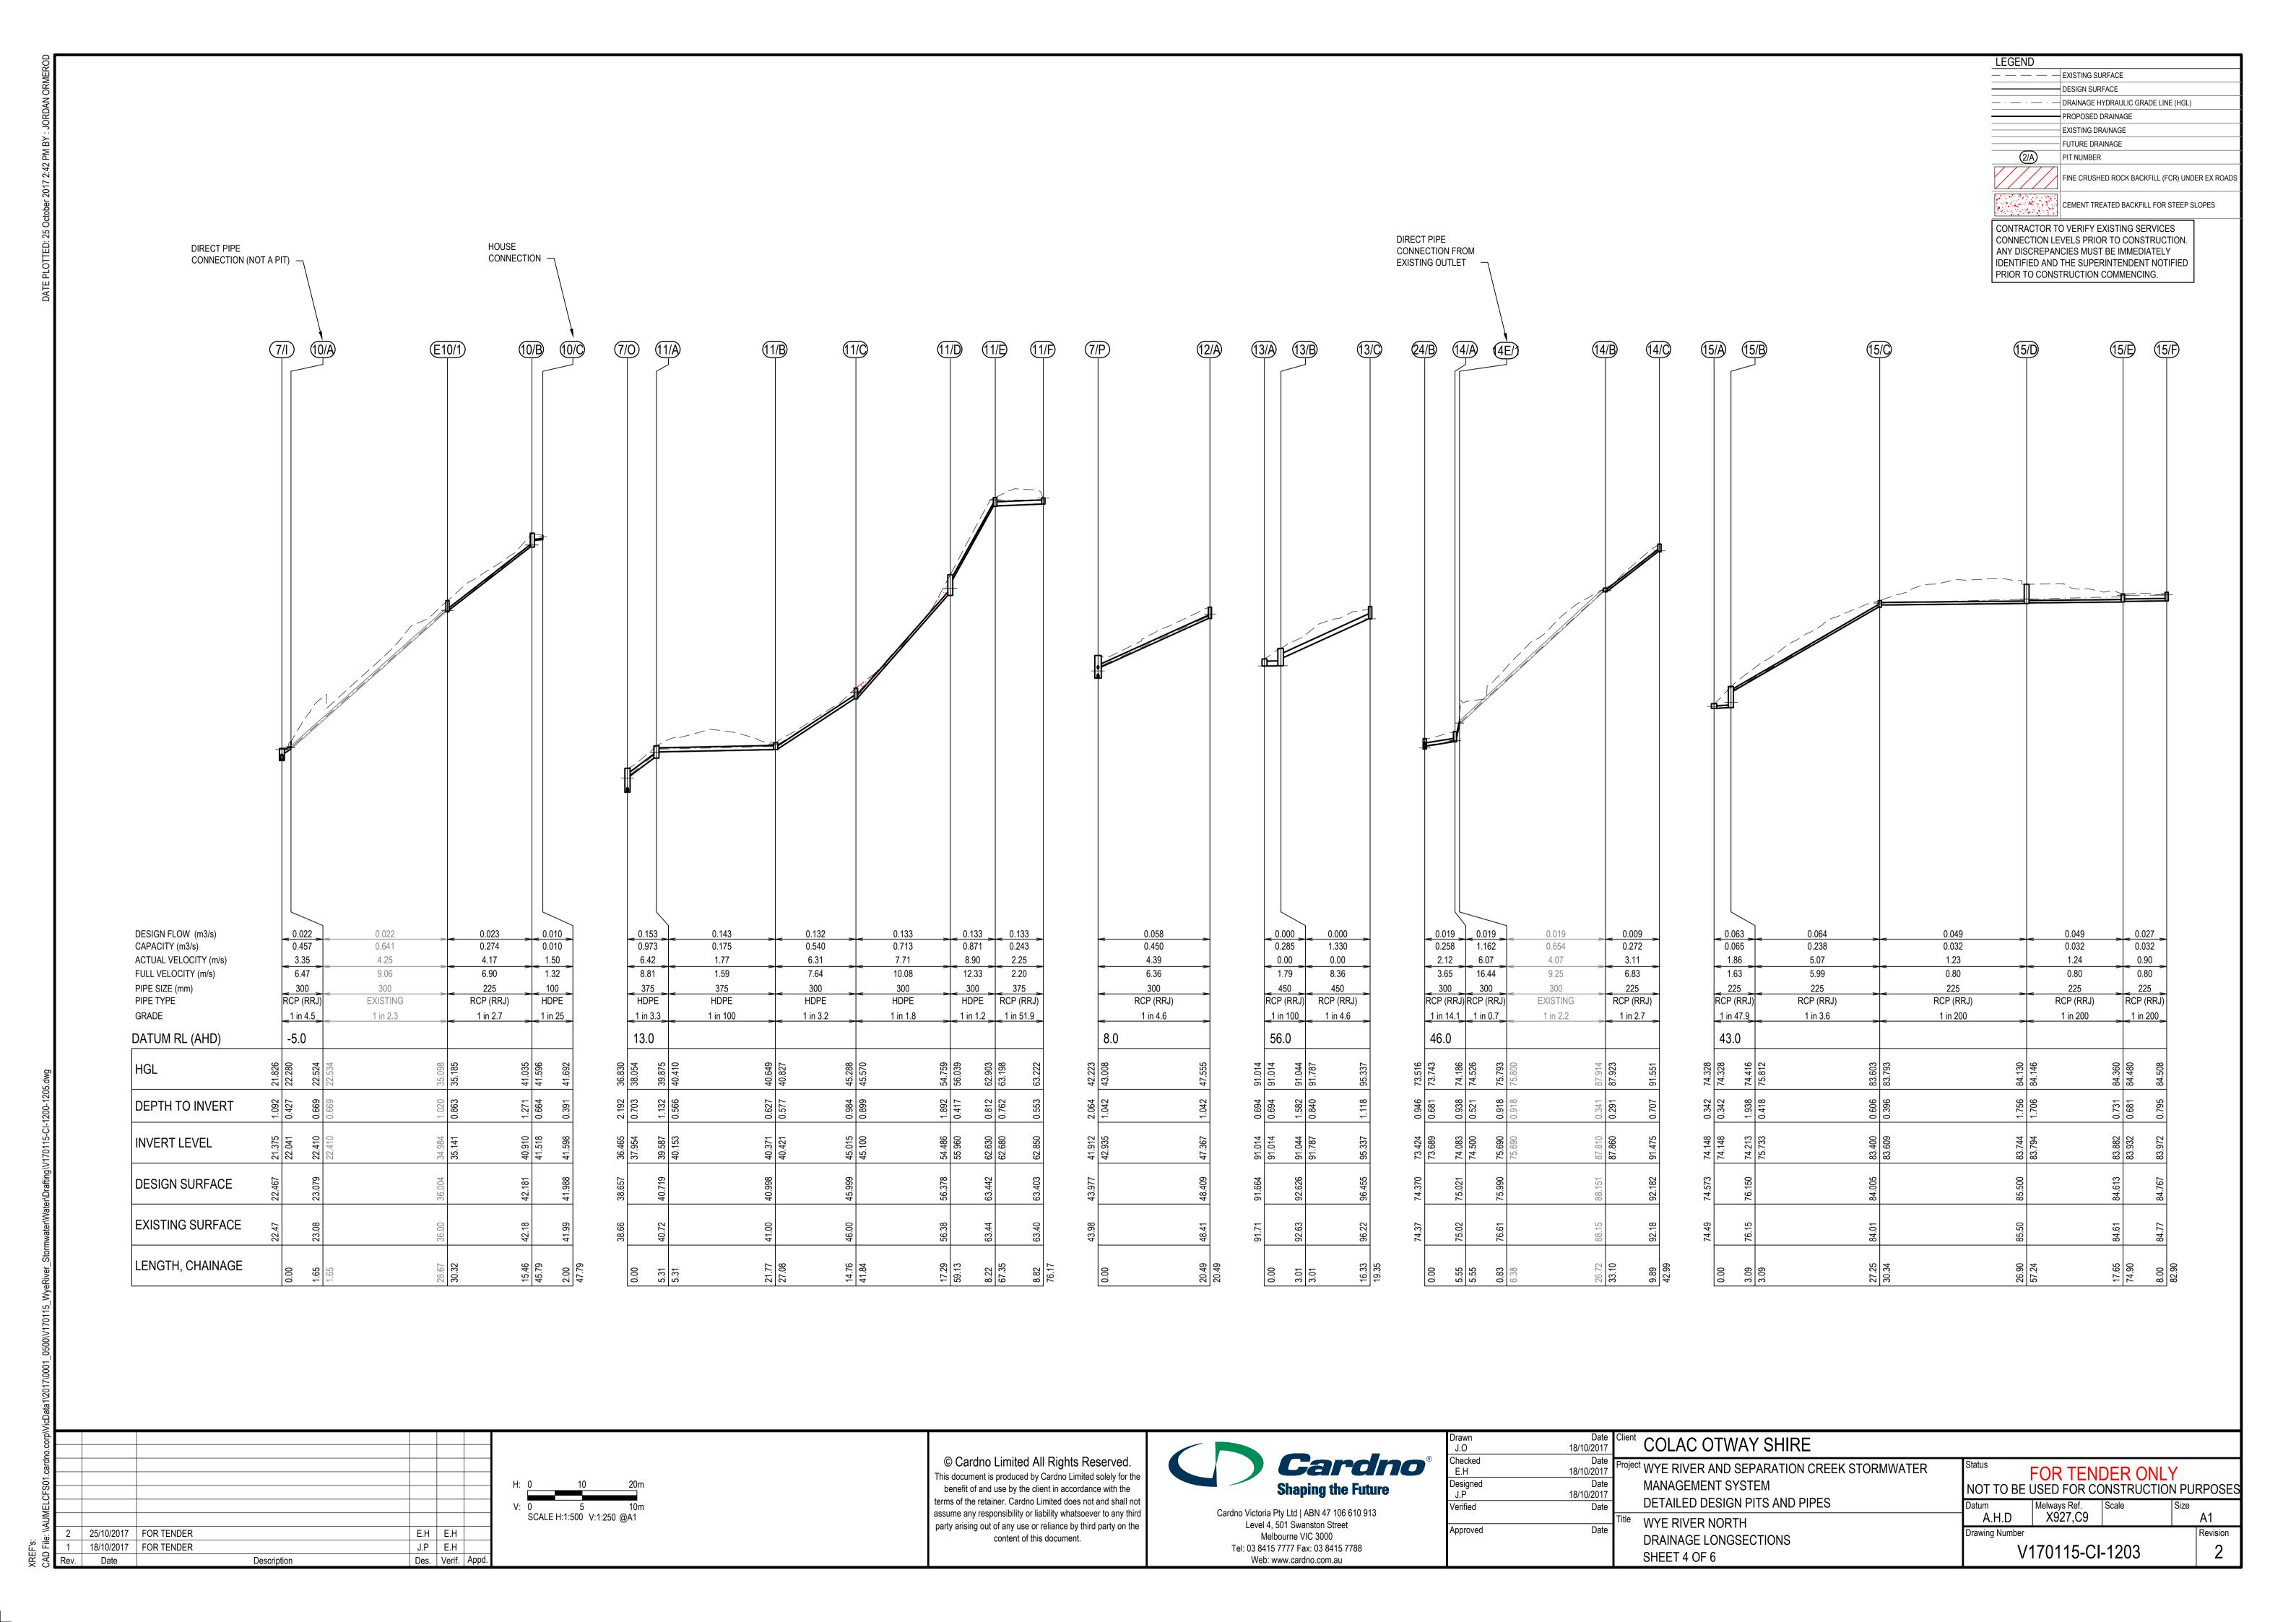

LEGEND

— — — EXISTING SURFACE

— DESIGN SURFACE

— DRAINAGE HYDRAULIC GRADE LINE (HGL)

— PROPOSED DRAINAGE

— EXISTING DRAINAGE

— FUTURE DRAINAGE

— FUTURE DRAINAGE

— FINE CRUSHED ROCK BACKFILL (FCR) UNDER EX ROADS

CEMENT TREATED BACKFILL FOR STEEP SLOPES


CONTRACTOR TO VERIFY EXISTING SERVICES

CONNECTION LEVELS PRIOR TO CONSTRUCTION.

ANY DISCREPANCIES MUST BE IMMEDIATELY

IDENTIFIED AND THE SUPERINTENDENT NOTIFIED

PRIOR TO CONSTRUCTION COMMENCING.

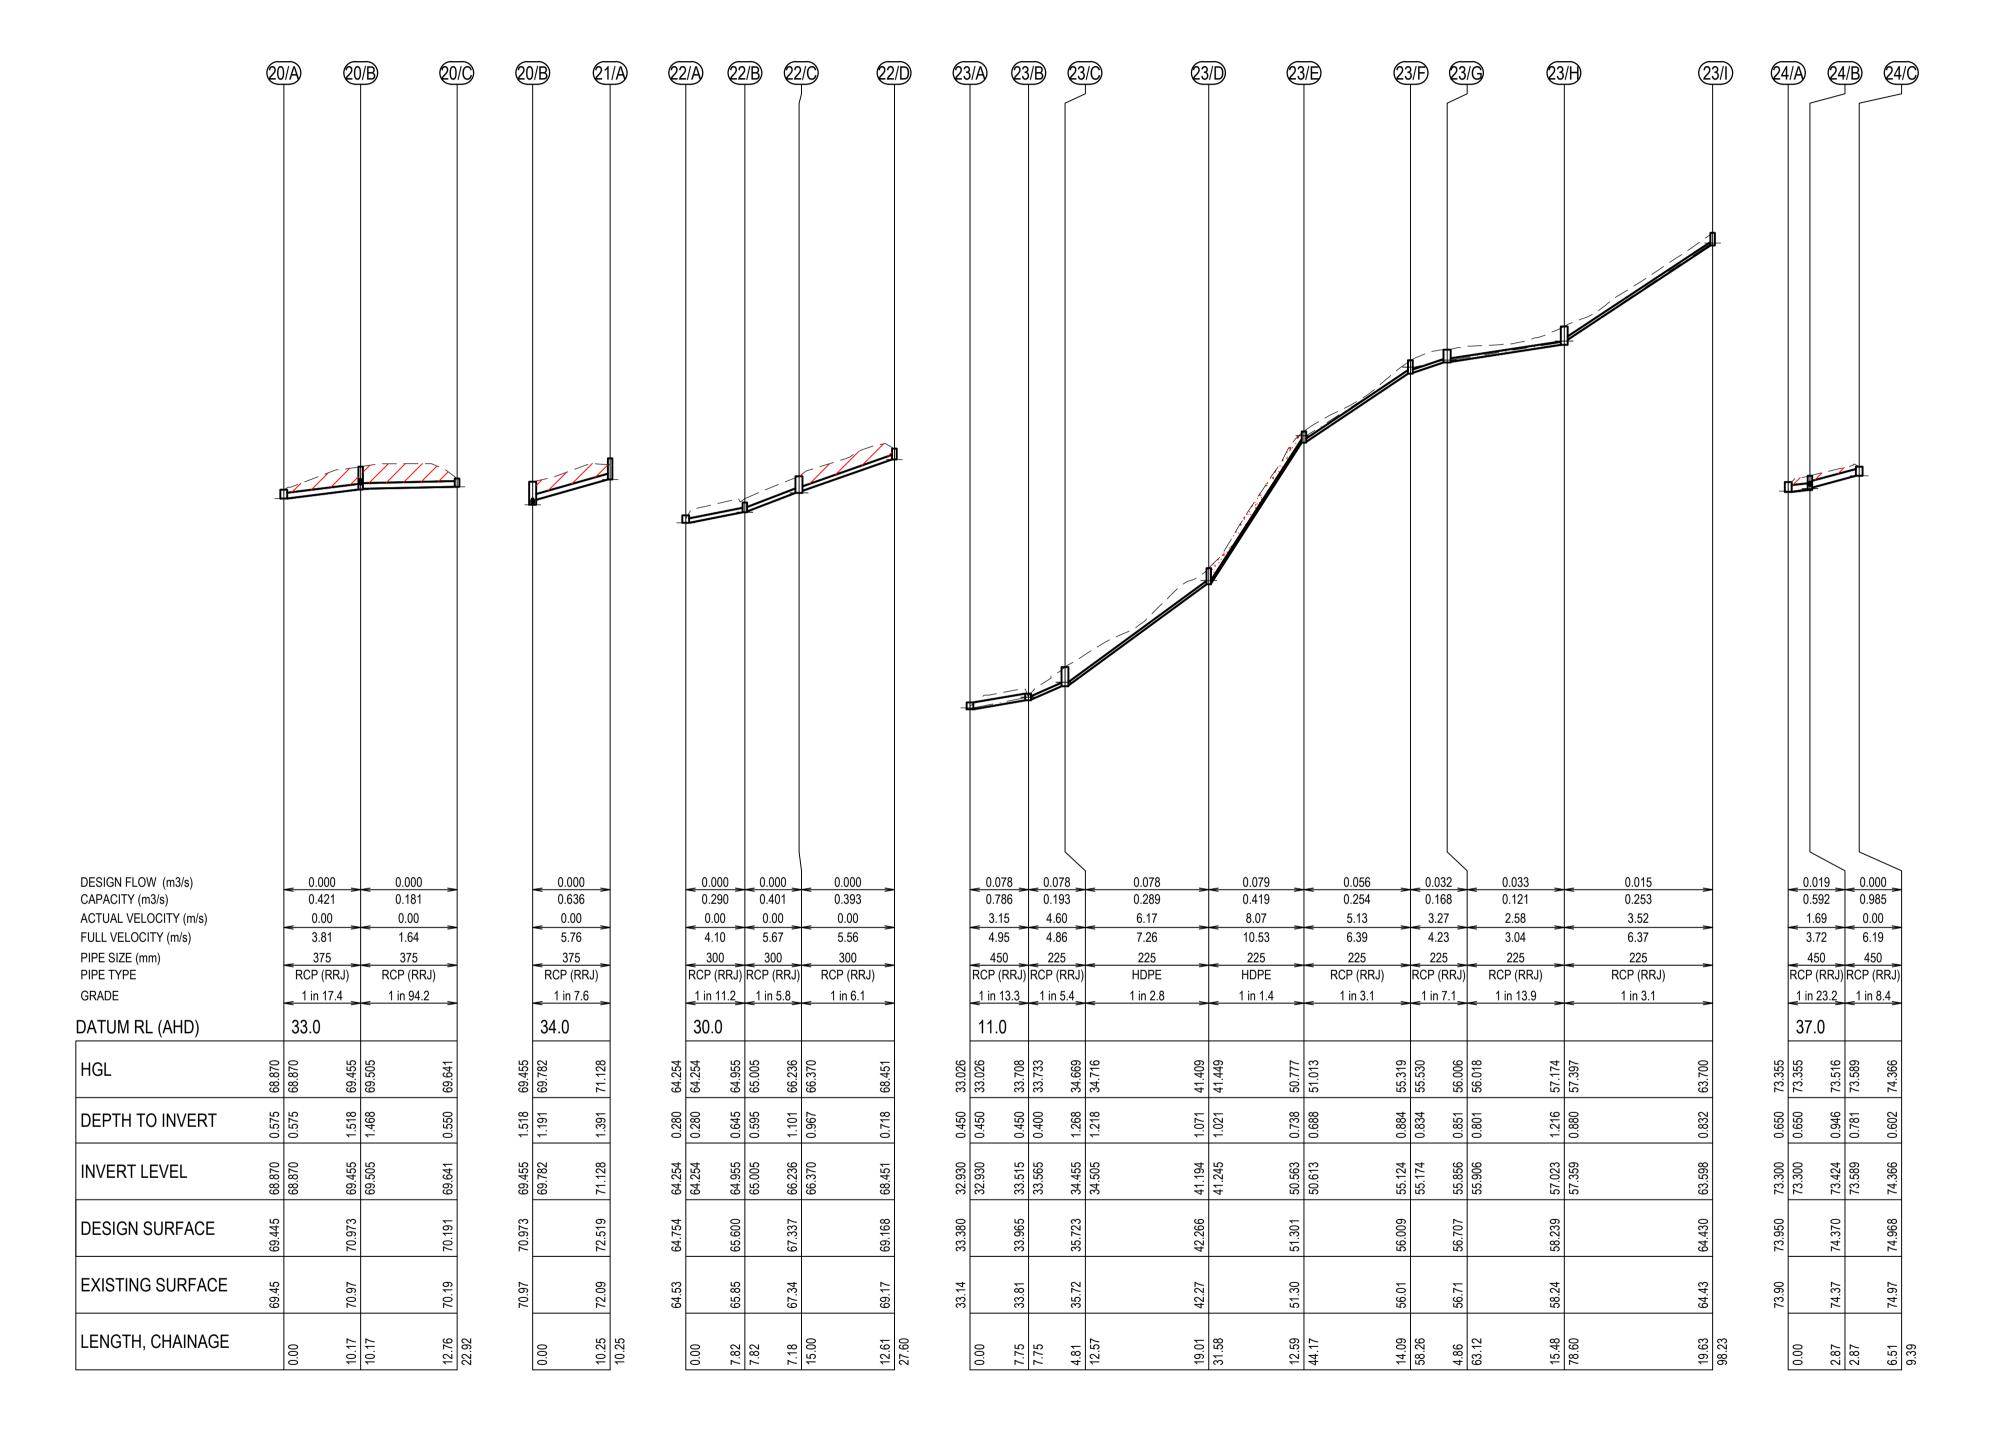

H: 0 10 20m
V: 0 5 10m
SCALE H:1:500 V:1:250 @A1

| 18/10/2017 | FOR TENDER | E.H | E.H |
| 18/10/2017 | FOR TENDER | J.P | E.H |
| Date | Description | Des. | Verif. | Appd.

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lient	COLAC OTWAY SHIRE
roject	WYE RIVER AND SEPARATION CREEK STORMWATER
	MANAGEMENT SYSTEM
	DETAILED DESIGN PITS AND PIPES
ïtle	WYE RIVER NORTH
	DRAINAGE LONGSECTIONS

SHEET 6 OF 6

FOR TENDER ONLY NOT TO BE USED FOR CONSTRUCTION PURP									
Datum Melways Ref. Scale Size A.H.D X927,C9									
Drawing Number Revisio									
V	170115-CI	-1205		2					

	PIT SCHEDULE												
	100/	ATION		INITE	RNAL	DIT COLUE	01.400.740			LET	OH.	TLET	
PIT NO			TYPE			PIT COVER	CLASS (AS 3996)	DEPTH					COMMENTS
	EASTING	NORTHING		WD	LEN	LEVEL	3990)		DIA	INV LEV	DIA	INV LEV	
1/A	752092.678	5720080.082	JP	900	900	32.051	В	2.05	300	31.600	300	30.000	REFER IDM SD 405 WITH LOCKABLE TERRAFIRMA COVER COLOURED GREEN. 40 Mpa CONCRETE PIT
									225	31.450			
1/B	752064.820	5720106.555	JP	900	900	44.170	В	1.46	225 300	31.483 43.256	300	42.715	REFER IDM SD 405 WITH LOCKABLE TERRAFIRMA COVER COLOURED GREEN. 40 Mpa CONCRETE PIT
1/C	752055.976	5720106.555	JP JP	600	600	50.689	D D	1.43	375	50.080	300	49.256	REFER IDM SD 405 WITH LOCKABLE TERRAFIRMA COVER COLOURED GREEN. 40 Mpa CONGRETE FTI
1/D	752050.737	5720121.234	HW	-	-	51.555	-	0.52	-	-	Ex375	51.030	REINFORCED CONCRETE WINGWALL. REFER IDM SD 465
2/A	752132.536	5720128.319	JP	600	600	33.079	В	0.53			225	32.550	REFER IDM SD 405 WITH LOCKABLE TERRAFIRMA COVER COLOURED GREEN
3/A	752066.849	5720063.909	JP	600	600	35.875	В	0.61			225	35.263	REFER IDM SD 405 WITH LOCKABLE TERRAFIRMA COVER COLOURED GREEN
4/A	752016.855	5720012.848	JP	600	600	34.512	В	0.71	225	34.100	225	33.800	REFER IDM SD 405 WITH LOCKABLE TERRAFIRMA COVER COLOURED GREEN. 40 Mpa CONCRETE PIT
4/B	752006.219	5720027.701	JP	900	900	43.824	В	1.82	225	42.058	225	42.008	REFER IDM SD 405 WITH LOCKABLE TERRAFIRMA COVER COLOURED GREEN
									225	42.963			
4/C	752032.042	5720050.202	JP	600	600	42.768	В	0.60		40.075	225	42.173	REFER IDM SD 405 WITH LOCKABLE TERRAFIRMA COVER COLOURED GREEN
5/A	751992.091	5720015.633	JP	900	600	44.023	В	1.00	225	43.075	225	43.025	REFER IDM SD 405 WITH LOCKABLE TERRAFIRMA COVER COLOURED GREEN
5/B 5/C	751976.496 751960.943	5720007.793 5719999.974	JP JP	900	600	45.534 46.613	B B	1.08 0.60	225	44.939	225 225	44.450 46.018	REFER IDM SD 405 WITH LOCKABLE TERRAFIRMA COVER COLOURED GREEN REFER IDM SD 405 WITH LOCKABLE TERRAFIRMA COVER COLOURED GREEN
6/A	751900.943	5720057.125	DEW	- 000	- 000	66.345	-	0.35	225	65.931	223	40.010	DRIVEABLE ENDWALL. REFER TYPICAL DETAIL
6/B	751916.853	5720055.577	GEP	600	600	66.416	D	0.47	225	66.000	225	65.950	REFER IDM SD 405 WITH GRATED CLASS D COVER
6/C	751920.699	5720058.836	JP	600	900	70.159	В	1.42	225	68.788	225	68.738	REFER IDM SD 405 WITH LOCKABLE TERRAFIRMA COVER COLOURED GREEN
6/D	751928.780	5720064.562	JP	600	900	72.989	В	1.41	225	72.533	225	71.581	REFER IDM SD 405 WITH LOCKABLE TERRAFIRMA COVER COLOURED GREEN
6/E	751942.545	5720077.268	JP	600	600	76.281	В	0.57	225	75.758	225	75.708	REFER IDM SD 405 WITH LOCKABLE TERRAFIRMA COVER COLOURED GREEN
6/F	751943.486	5720091.857	JP	600	600	80.070	В	0.98	225	79.140	225	79.090	REFER IDM SD 405 WITH LOCKABLE TERRAFIRMA COVER COLOURED GREEN
6/G	751932.519	5720103.557	JP	600	600	83.651	В	0.65	225	83.071	225	83.004	REFER IDM SD 405 WITH LOCKABLE TERRAFIRMA COVER COLOURED GREEN
6/H	751914.088	5720123.219	JP	600	600	86.583	В	0.57	600	0.047	225	86.014	REFER IDM SD 405 WITH LOCKABLE TERRAFIRMA COVER COLOURED GREEN
7/A 7/B	751734.595 751739.970	5719960.354 5719961.857	EW JP	900	900	7.447 8.380	- D	0.84 1.53	600	6.647 7.300	600	6.850	ROCKED OUTLET TYPE 1. REFER TO TYPICAL DETAILS HAUNCHED PIT WITH 600 X 900 ACCESS. CLASS D ASPHALT INFILL COVER. REFER IDM SD 410
7/B	751739.970 751751.335	5719961.857	GEP	900	900	11.243	D D	1.53	525	10.144	600	10.064	HAUNCHED PIT WITH 600 X 900 ACCESS. CLASS D ASPHALT INFILL COVER. REFER IDM SD 410 HAUNCHED PIT WITH 600 X 900 AND DEPRESSED GRATE. REFER IDM SD 455 & SD 410
7/D	751799.939	5719964.170	JP	900	900	12.756	D	1.10	525	11.571	525	11.471	HAUNCHED PIT WITH 600 X 900 AND DEPRESSED GRATE. REFER IDM SD 433 & 3D 410 HAUNCHED PIT WITH 600 X 900 ACCESS. CLASS D COVER. REFER IDM SD 410
7/E	751829.397	5719954.064	GEP	900	900	13.794	D	1.39	525	12.608	525	12.408	HAUNCHED PIT WITH 600 X 900 ACCESS. GRATED CLASS D COVER. REFER IDM SD 410
7/F	751838.942	5719964.766	JP	900	900	16.060	D	1.49	525	14.791	525	14.568	HAUNCHED PIT WITH 600 X 900 ACCESS. GRATED CLASS D COVER. REFER IDM SD 410
									300	14.860			
7/G	751843.317	5719969.011	GEP	900	900	16.970	D	1.79	525	15.234	525	15.184	HAUNCHED PIT WITH 600 X 900 CUSTOM ANGLED GRILL. CLASS D COVER. REFER TYPICAL DETAIL
7/H	751843.400	5719986.682	JP	900	900	19.437	D	1.25	525	18.338	525	18.188	HAUNCHED PIT WITH 600 X 900 ACCESS. CLASS D COVER. REFER IDM SD 410
7/I	751843.017	5720005.423	GEP	900	900	22.467	D	1.09	525	21.425	525	21.375	HAUNCHED PIT WITH 600 X 900 ACCESS. GRATED CLASS D COVER. REFER IDM SD 410
7/1	754000 007	5700000 524	ID	000	000	00.400	6	4.00	300	22.041	505	00.000	HALINGHED DIT WITH COO Y COO ACCEDE OF ACC D COVED DEFED IDM CD 440
7/J 7/K	751830.697 751807.332	5720009.534 5720031.407	JP JP	900	900	23.496 26.463	D D	1.20 1.24	525 525	22.343 25.273	525 525	22.293 25.223	HAUNCHED PIT WITH 600 X 900 ACCESS. CLASS D COVER. REFER IDM SD 410 HAUNCHED PIT WITH 600 X 900 ACCESS. CLASS D COVER. REFER IDM SD 410
7/L	751807.532	5720031.407	GEP	900	900	27.930	D	1.24	375	27.042	525	26.735	HAUNCHED PIT WITH 600 X 900 ACCESS. CLASS D COVER. REFER IDM 3D 410 HAUNCHED PIT WITH 600 X 900 CUSTOM ANGLED GRILL. CLASS D COVER. REFER TYPICAL DETAIL
7/L	751803.414	5720050.516	JP	900	900	30.557	В	1.82	375	29.887	375	28.742	HAUNCHED PIT WITH 600 X 900 LOCKABLE TERRAFIRMA COVER COLOURED GREEN
7/N	751809.443	5720063.500	JP	900	900	35.582	В	2.15	375	35.009	375	33.433	HAUNCHED PIT WITH 600 X 900 LOCKABLE TERRAFIRMA COVER COLOURED GREEN
7/0	751819.770	5720085.738	JP	900	900	38.657	В	2.19	375	36.515	375	36.465	HAUNCHED PIT WITH 600 X 900 LOCKABLE TERRAFIRMA COVER COLOURED GREEN
									375	37.954			
7/P	751796.026	5720107.630	JP	900	900	43.977	В	2.06	300	42.755	375	41.912	HAUNCHED PIT WITH 600 X 900 LOCKABLE TERRAFIRMA COVER COLOURED GREEN
							_		300	42.935			
7/Q	751805.488	5720145.150	JP JP	600	900	54.886	В	1.32	300	53.743	300	53.568	REFER IDM SD 405 WITH LOCKABLE TERRAFIRMA COVER COLOURED GREEN
7/R 7/S	751815.293 751817.133	5720184.032 5720190.201	JP JP	900	900	65.490 67.765	B D	1.36 1.11	300 300	64.791 66.708	300 300	64.128 66.658	REFER IDM SD 405 WITH LOCKABLE TERRAFIRMA COVER COLOURED GREEN REFER IDM SD 405 WITH CLASS D COVER
7/3 7/T	751812.556	5720198.052	JP	900	900	67.679	D	0.88	300	00.700	300	66.799	DEPRESSED GRATE WITH CLASS D COVER. REFER IDM SD 455
8/A	751860.207	5719945.736	JP	600	900	21.769	D	1.23	300	20.672	300	20.535	REFER IDM SD 405 WITH CLASS D COVER
8/B	751871.184	5719938.687	JP	600	600	22.063	D	0.95	300	21.269	300	21.117	REFER IDM SD 405 WITH CLASS D COVER
8/C	751892.327	5719945.647	JP	600	600	29.797	В	0.62	300	29.225	300	29.175	REFER IDM SD 405 WITH LOCKABLE TERRAFIRMA COVER COLOURED GREEN
8/D	751906.404	5719953.303	JP	600	900	33.781	В	1.14	300	33.840	300	32.643	REFER IDM SD 405 WITH LOCKABLE TERRAFIRMA COVER COLOURED GREEN
9/A	751914.741	5719975.321	JP	600	600	42.549	В	0.75	225	42.065	225	41.798	REFER IDM SD 405 WITH LOCKABLE TERRAFIRMA COVER COLOURED GREEN
9/B	751901.908	5719999.207	GEP	600	900	49.194	D	1.08	225	48.311	225	48.115	REFER IDM SD 405 WITH GRATED CLASS D COVER
9/C	751903.017	5720010.004	GEP	600	900	52.094	D	1.53	225	50.616	225	50.566	REFER IDM SD 405 WITH GRATED CLASS D COVER
9/D	751915.612	5720014.800	GEP	600	900	54.608	D	1.56	100	44 540	225	53.049	REFER IDM SD 405 WITH GRATED CLASS D COVER
10/B 11/A	751865.882 751824.415	5720043.114 5720088.317	JP JP	900	900	42.181 40.719	B B	1.27 1.13	100 375	41.518 40.153	225 375	40.910 39.587	REFER IDM SD 405 WITH LOCKABLE TERRAFIRMA COVER COLOURED GREEN REFER IDM SD 405 WITH LOCKABLE TERRAFIRMA COVER COLOURED GREEN
11/A 11/B	751824.415	5720086.317	JP JP	600	900	40.998	В	0.63	300	40.421	375	40.371	REFER IDM SD 405 WITH LOCKABLE TERRAFIRMA COVER COLOURED GREEN REFER IDM SD 405 WITH LOCKABLE TERRAFIRMA COVER COLOURED GREEN. 40 Mpa CONCRETE PIT
11/C	751849.577	5720084.296	JP	900	600	45.999	В	0.03	300	45.100	300	45.015	REFER IDM SD 405 WITH LOCKABLE TERRAFIRMA COVER COLOURED GREEN. 40 Mpa CONCRETE PIT
11/D	751865.305	5720091.467	JP	600	900	56.378	В	1.89	300	55.960	300	54.486	REFER IDM SD 405 WITH LOCKABLE TERRAFIRMA COVER COLOURED GREEN. 40 Mpa CONCRETE PIT
11/E	751871.232	5720097.165	JP	600	600	63.442	D	0.81	375	62.680	300	62.630	JUNCTION PIT WITH CLASS D COVER. REFER IDM SD 405
11/F	751873.629	5720105.655	GEP	600	600	63.403	D	0.55			375	62.850	DEPRESSED GRATE. REFER IDM SD 455
12/A	751784.138	5720124.322	JP	600	600	48.409	В	1.04			300	47.367	DEPRESSED GRATE. REFER IDM SD 455
13/A	751824.514	5720275.427	DEW	-	-	91.664	<u>-</u>	0.69	450	91.014	-	-	DRIVEABLE ENDWALL. REFER TYPICAL DETAIL
13/B	751825.094	5720278.382	JP	900	900	92.626	D	1.58	450	91.787	450	91.044	HAUNCHED PIT WITH 600 X 900 ACCESS. CLASS D COVER. REFER IDM SD 410. 40MPa CONCRETE PIT
13/C	751814.004 751688.400	5720290.376	JP	900	600	96.455 75.021	D	1.12	200	74.500	450 300	95.337	INLET CATCH PIT REFER IDM SD 460
14/A 14/B	751688.400 751684.032	5720214.755 5720241.904	GEP JP	600 600	600	75.021 88.151	D B	0.94 0.34	300 225	74.500 87.860	300 Ex300	74.083 87.810	REFER IDM SD 405 WITH GRATED CLASS D COVER REFER IDM SD 405 WITH LOCKABLE TERRAFIRMA COVER COLOURED GREEN. 40MPa CONCRETE PIT
14/B 14/C	751684.032 751689.390	5720241.904	JP JP	600	600	92.182	В	0.34	223	00.10	225	91.475	REFER IDM SD 405 WITH LOCKABLE TERRAFIRMA COVER COLOURED GREEN. 40MPa CONCRETE PIT
15/A	751526.357	5720202.269	HW	-	-	74.573	-	0.71	225	74.148		01.710	REINFORCED CONCRETE WINGWALL. REFER IDM SD 465
15/B	751529.303	5720203.214	JP	900	900	76.150	В	1.94	225	75.733	225	74.213	REFER IDM SD 405 WITH GRATED COVER
15/C	751556.431	5720200.662	JP	600	600	84.005	В	0.61	225	83.609	225	83.400	REFER IDM SD 405 WITH GRATED COVER
15/D	751583.329	5720200.253	JP	900	900	85.500	В	1.76	225	83.794	225	83.744	REFER IDM SD 405 WITH GRATED COVER
15/E	751600.982	5720200.335	JP	600	600	84.613	В	0.73	225	83.932	225	83.882	REFER IDM SD 405 WITH GRATED COVER
15/F	751608.089	5720204.010	JP	600	600	84.767	В	0.80	150	84.203	225	83.972	REFER IDM SD 405 WITH GRATED COVER
15/G	751650.336	5720225.853	JP	600	600	90.188	В	0.34			225	89.755	REFER IDM SD 405 WITH GRATED COVER
16/A	751728.481	5720044.007	HW	-	-	20.000	-	0.50	300	19.500	222	10.000	REINFORCED CONCRETE WINGWALL. REFER IDM SD 465
16/B	751723.082	5720049.611	GEP	900	600	20.615	В	0.98	300	19.688	300	19.638	REFER IDM SD 405 WITH LOCKARI E TERRAFIRMA COVER COLOURED CREEN
16/C	751706.157 751702.283	5720057.139	JP	600	900	25.506	В	1.64	300	24.401	300	23.865	REFER IDM SD 405 WITH LOCKABLE TERRAFIRMA COVER COLOURED GREEN
16/D 17/A	751702.283 751547.341	5720071.105 5720111.871	GEP HW	900	900	29.197 40.867	D	1.85 0.87	675	39.992	300	27.351	REFER IDM SD 405 WITH GRATED COVER REINFORCED CONCRETE WINGWALL. REFER VIC ROADS SD 1931 ISSUE C
17/A 17/B	751547.341 751549.427	5720111.871	JP	900	900	40.867	- D	1.80	675	39.992 40.605	675	40.025	HAUNCHED PIT WITH 600 X 900 ACCESS. CLASS D COVER. REFER IDM SD 410
			•										HAUNCHED PIT WITH 600 X 900 ACCESS. GRATED CLASS D COVER. 40Mpa CONCRETE PIT. REFER IDM 5
17/C	751559.545	5720117.215	GEP	900	900	42.357	D	1.36	450	41.324	675	40.996	410
17/D	751577.794	5720132.985	GEP	900	900	59.177	D -	1.55	450	57.742	450	57.623	HAUNCHED PIT WITH 600 X 900 ACCESS. GRATED CLASS D COVER. REFER IDM SD 410
17/E	751595.715 751626.670	5720136.421 5720139.533	JP	900	900	59.697	D	1.58	450	58.645	450	58.117	HAUNCHED PIT WITH 600 X 900 ACCESS. CLASS D COVER. REFER IDM SD 410
17/F		1 27/20139 533	GEP	900	900	63.500	D	0.96		1	450	62.543	HAUNCHED PIT WITH 600 X 900 CUSTOM ANGLED GRILL. CLASS D COVER. REFER TYPICAL DETAIL

E.H E.H

J.P E.H

Des. Verif. Appd. 25/10/2017 FOR TENDER 18/10/2017 FOR TENDER Description Rev. Date

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	Drawn J.O	Date 18/10/2017	C
3	Checked E.H	Date 18/10/2017	Ρ
	Designed J.P	Date 18/10/2017	
	Verified	Date	T
	Approved	Date	

COLAC OTWAY SHIRE Project WYE RIVER AND SEPARATION CREEK STORMWATER MANAGEMENT SYSTEM DETAILED DESIGN PITS AND PIPES Title WYE RIVER NORTH

DRAINAGE PIT SCHEDULE

SHEET 1 OF 2

FOR TENDER ONLY NOT TO BE USED FOR CONSTRUCTION PURPOSES							
Datum A.H.D	Melways Ref. X927,C9	Scale	Size	A1			
Drawing Number Revision							
V170115-CI-1210 2							

	PIT SCHEDULE												
DIT NO	LOCA	TION	TVDE	INTE	RNAL	PIT COVER	CLASS (AS	DEDTU	IN	LET	OU	TLET	COMMENTO
PIT NO	EASTING	NORTHING	TYPE	WD	LEN	LEVEL	3996)	DEPTH	DIA	INV LEV	DIA	INV LEV	COMMENTS
18/A	751513.105	5720149.899	HW	-	-	55.249	-	0.43	225	54.824			REINFORCED CONCRETE WINGWALL. REFER IDM SD 465
18/B	751510.529	5720149.033	GEP	600	900	56.297	В	1.43	225	55.897	225	54.866	REFER IDM SD 405 WITH GRATED COVER. 40MPa CONCRETE PIT
18/C	751480.191	5720139.424	GEP	600	600	68.064	В	0.77	225	67.343	225	67.293	REFER IDM SD 405 WITH GRATED COVER
18/D	751445.067	5720136.128	GEP	900	900	75.277	В	1.43	225	73.893	225	73.843	REFER IDM SD 405 WITH GRATED COVER
18/E	751401.264	5720120.096	GEP	600	600	75.457	В	1.10			225	74.359	REFER IDM SD 405 WITH GRATED COVER
19/A	751285.967	5720131.699	DEW	-	-	79.405	-	0.53	525	78.880			DRIVEABLE ENDWALL. REFER TYPICAL DETAIL
19/B	751280.458	5720142.472	DEW	-	-	82.595	-	0.53			525	82.070	DRIVEABLE ENDWALL. REFER TYPICAL DETAIL
20/A	751296.858	5720070.455	DEW	-	-	69.445	-	0.57	375	68.870			DRIVEABLE ENDWALL. REFER TYPICAL DETAIL
20/B	751286.693	5720070.496	JP	900	600	70.973	D	1.52	375	69.505	375	69.455	REFER IDM SD 405 WITH CLASS D ASPHALT INFILL COVER
									375	69.782			
20/C	751273.935	5720070.581	GEP	900	600	70.191	D	0.55			375	69.641	DEPRESSED GRATE. REFER IDM SD 455
21/A	751284.075	5720080.402	JP	600	600	72.519	D	1.39			375	71.128	INLET CATCH PIT REFER IDM SD 460
22/A	751130.411	5720081.091	DEW	-	-	64.754	-	0.50	300	64.254			DRIVEABLE ENDWALL. REFER TYPICAL DETAIL
22/B	751137.449	5720084.495	GEP	600	600	65.600	D	0.65	300	65.005	300	64.955	DEPRESSED GRATE. REFER IDM SD 455
22/C	751144.358	5720086.444	GEP	600	900	67.337	D	1.10	300	66.370	300	66.236	REFER IDM SD 405 WITH GRATED COVER
22/D	751151.887	5720096.554	GEP	900	600	69.168	D	0.72			300	68.451	DEPRESSED GRATE. REFER IDM SD 455
23/A	751236.984	5719953.089	DEW	-	-	33.380	-	0.45	450	32.930			DRIVEABLE ENDWALL. REFER TYPICAL DETAIL
23/B	751230.057	5719956.569	DEW	-	-	33.965	-	0.45	225	33.565	450	33.515	DRIVEABLE ENDWALL. REFER TYPICAL DETAIL
23/C	751231.303	5719961.219	JP	600	900	35.723	В	1.27	225	34.505	225	34.455	REFER IDM SD 405 WITH LOCKABLE TERRAFIRMA COVER COLOURED GREEN. 40MPa CONCRETE PIT
23/D	751240.163	5719978.038	JP	600	600	42.266	В	1.07	225	41.245	225	41.194	REFER IDM SD 405 WITH LOCKABLE TERRAFIRMA COVER COLOURED GREEN. 40MPa CONCRETE PIT
23/E	751245.973	5719989.210	JP	600	600	51.301	В	0.74	225	50.613	225	50.563	REFER IDM SD 405 WITH LOCKABLE TERRAFIRMA COVER COLOURED GREEN. 40MPa CONCRETE PIT
23/F	751252.703	5720001.593	JP	600	600	56.009	В	0.88	225	55.174	225	55.124	REFER IDM SD 405 WITH LOCKABLE TERRAFIRMA COVER COLOURED GREEN
23/G	751249.632	5720005.359	JP	600	900	56.707	В	0.85	225	55.906	225	55.856	REFER IDM SD 405 WITH LOCKABLE TERRAFIRMA COVER COLOURED GREEN
23/H	751235.511	5720011.692	JP	600	900	58.239	В	1.22	225	57.359	225	57.023	REFER IDM SD 405 WITH LOCKABLE TERRAFIRMA COVER COLOURED GREEN
23/I	751216.880	5720017.870	JP	600	600	64.430	В	0.83			225	63.598	REFER IDM SD 405 WITH LOCKABLE TERRAFIRMA COVER COLOURED GREEN
24/A	751687.982	5720208.212	DEW	-	-	73.950	-	0.65	450	73.300			DRIVEABLE ENDWALL. REFER TYPICAL DETAIL
24/B	751690.490	5720209.615	JP	600	600	74.370		0.95	300	73.689	450	73.424	REFER IDM SD 405 WITH CLASS D COVER
								0.95	450	73.589			
24/C	751696.525	5720212.068	DEW	-	-	74.968		0.60			450	74.366	DRIVEABLE ENDWALL. REFER TYPICAL DETAIL
25/A	751684.702	5720155.175	HW	-	-	51.300		0.54			150	50.760	REINFORCED CONCRETE WINGWALL. REFER IDM SD 465

- NOTES:

 1. ALL PITS ARE TO BE TO IDM STANDARDS UNLESS NOTED OTHERWISE.
- 2. PITS DEEPER THAN 1.00m SHALL BE FITTED WITH STEPIRONS, FIRST STEPIRON TO BE 300mm FROM THE BOTTOM OF THE PIT. COVER LEVELS TO BE SET TO MATCH THE FINISHED SURFACE PROFILES AND ADJACENT CONSTRUCTION.
- 4. GP = GRATED PIT, GSEP = SIDE ENTRY PIT GRATED, DGSEP = DOUBLE SIDE ENTRY PIT GRATED, SEP = SIDE ENTRY PIT, DSEP = DOUBLE SIDE ENTRY PIT, JP = JUNCTION PIT, EP = END OF PIPE,
- EW = ENDWALL, DEW = DRIVEABLE ENDWALL. 5. UNLESS OTHERWISE SPECIFIED, PIT TYPES REFER TO IDM STANDARD DRAWINGS
 - FIGURE SD 405 UNHAUNCHED PITS (450Ø MAX. PIPE)
 - FIGURE SD 410 HAUNCHED PITS (MIN 525Ø PIPE) FIGURE SD 420 JUNCTION PIT IN ROAD RESERVE
 - FIGURE SD 426 JUNCTION PIT WITH NON-CONCRETE COVER (NON TRAFFICABLE AREAS)
 - FIGURE SD 441 GRATED SIDE ENTRY PIT WITH LIGHTWEIGHT COVER & CONCRETE SURROUND FOR 'SM2-M'
 - FIGURE SD 455 DEPRESSED GRATED PIT FIGURE SD 460 INLET CATCH PIT
 - FIGURE SD 465 REINFORCED CONCRETE WINGWALL (IN-SITU)
 - FIGURE SD 470 CONCRETE ENDWALL FOR PIPES UP TO 300mmØ (WALKWAYS, PATHS AND TRACKS)
 - FIGURE SD 480 GRATED PIT FOR SM2 MODIFIED KERB & CHANNEL • FIGURE SD 481 ALTERNATE GRATED PIT FOR SM2 MODIFIED KERB & CHANNEL 'SM2-M' - UPSTREAM PIT ONLY
- FIGURE SD 496 MODIFIED EXISTING PIT TO GRATED PIT IN VEHICLE CROSSING / LAYBACK FOR HAUNCHED PITS REFER TO IDM STANDARD DRAWING FIGURE SD 410. PITS TO BE HAUNCHED TO COUNCIL STANDARD OPENINGS.
- 7. STUBS AND PIPE ENDS TO BE BLOCKED OFF TO COUNCIL'S SATISFACTION.
- 8. ALL GRATED PITS TO HAVE BICYCLE SAFE LOCKDOWN GRATES.
- 9. ALL GRATED SIDE-ENTRY PITS TO HAVE MIN 100mm THICK CONCRETE APRON BETWEEN GRATE AND ASPHALT. REFER IDM STANDARD DRAWINGS.
- 10. PITS WITHIN ROAD PAVEMENT, VEHICLE CROSSINGS OR WITHIN 0.75m OF A VEHICLE CROSSING, TO HAVE CLASS D CAST IRON LOCK DOWN LIDS, LID INFILL COLOURED TO MATCH ROAD
- 11. ALL PITS WITHIN ROAD TO BE CONSTRUCTED WITH 32 MPa CONCRETE WITH SL92 MESH IN WALLS AND BASE.
- 12. CONTRACTOR TO VERIFY EXISTING SERVICES CONNECTION LEVELS PRIOR TO CONSTRUCTION. ANY DISCREPANCIES MUST BE IMMEDIATELY IDENTIFIED AND THE SUPERINTENDENT NOTIFIED PRIOR TO CONSTRUCTION COMMENCING.

2	25/10/2017	FOR TENDER	E.H	E.H		
1	18/10/2017	FOR TENDER	J.P	E.H		
Rev.	Date	Description	Des.	Verif.	Appd.	

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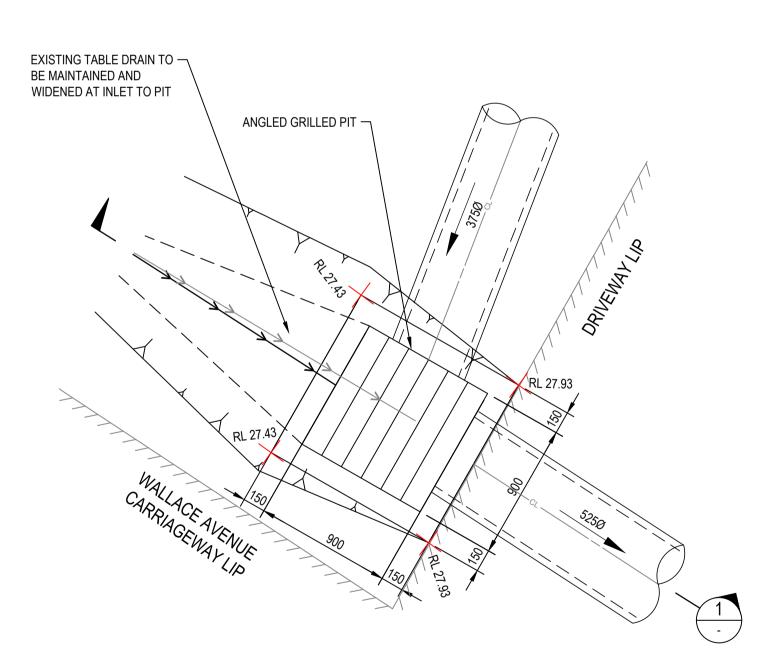
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SHEET 2 OF 2


ient COLAC OTWAY SHIRE Project WYE RIVER AND SEPARATION CREEK STORMWATER FOR TENDER ONLY MANAGEMENT SYSTEM NOT TO BE USED FOR CONSTRUCTION PURPOSES DETAILED DESIGN PITS AND PIPES A.H.D X927,C9 Fitle WYE RIVER NORTH Drawing Number DRAINAGE PIT SCHEDULE V170115-CI-1211


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NOT TO SCALE





PIT DETAIL - 7/L SCALE 1:25




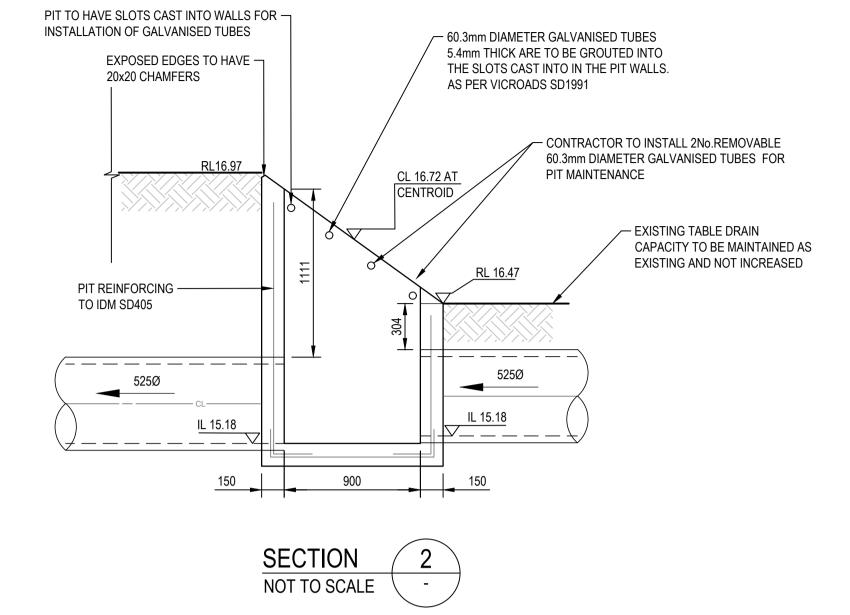

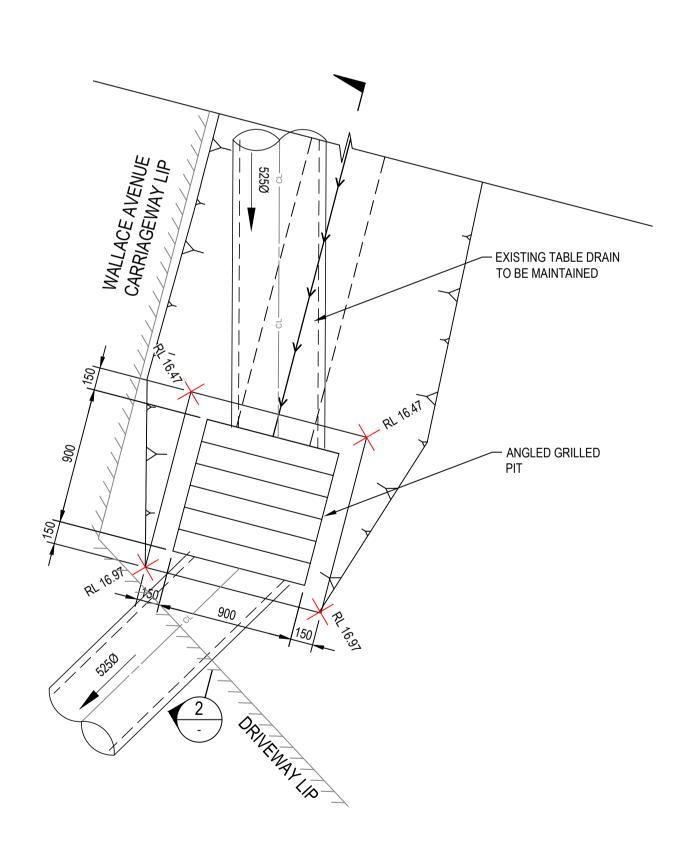PIT DETAIL - 7/G SCALE 1:25

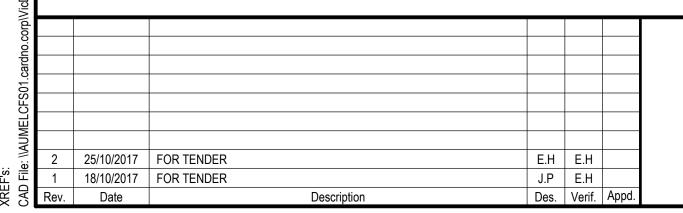

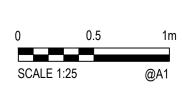

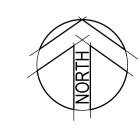


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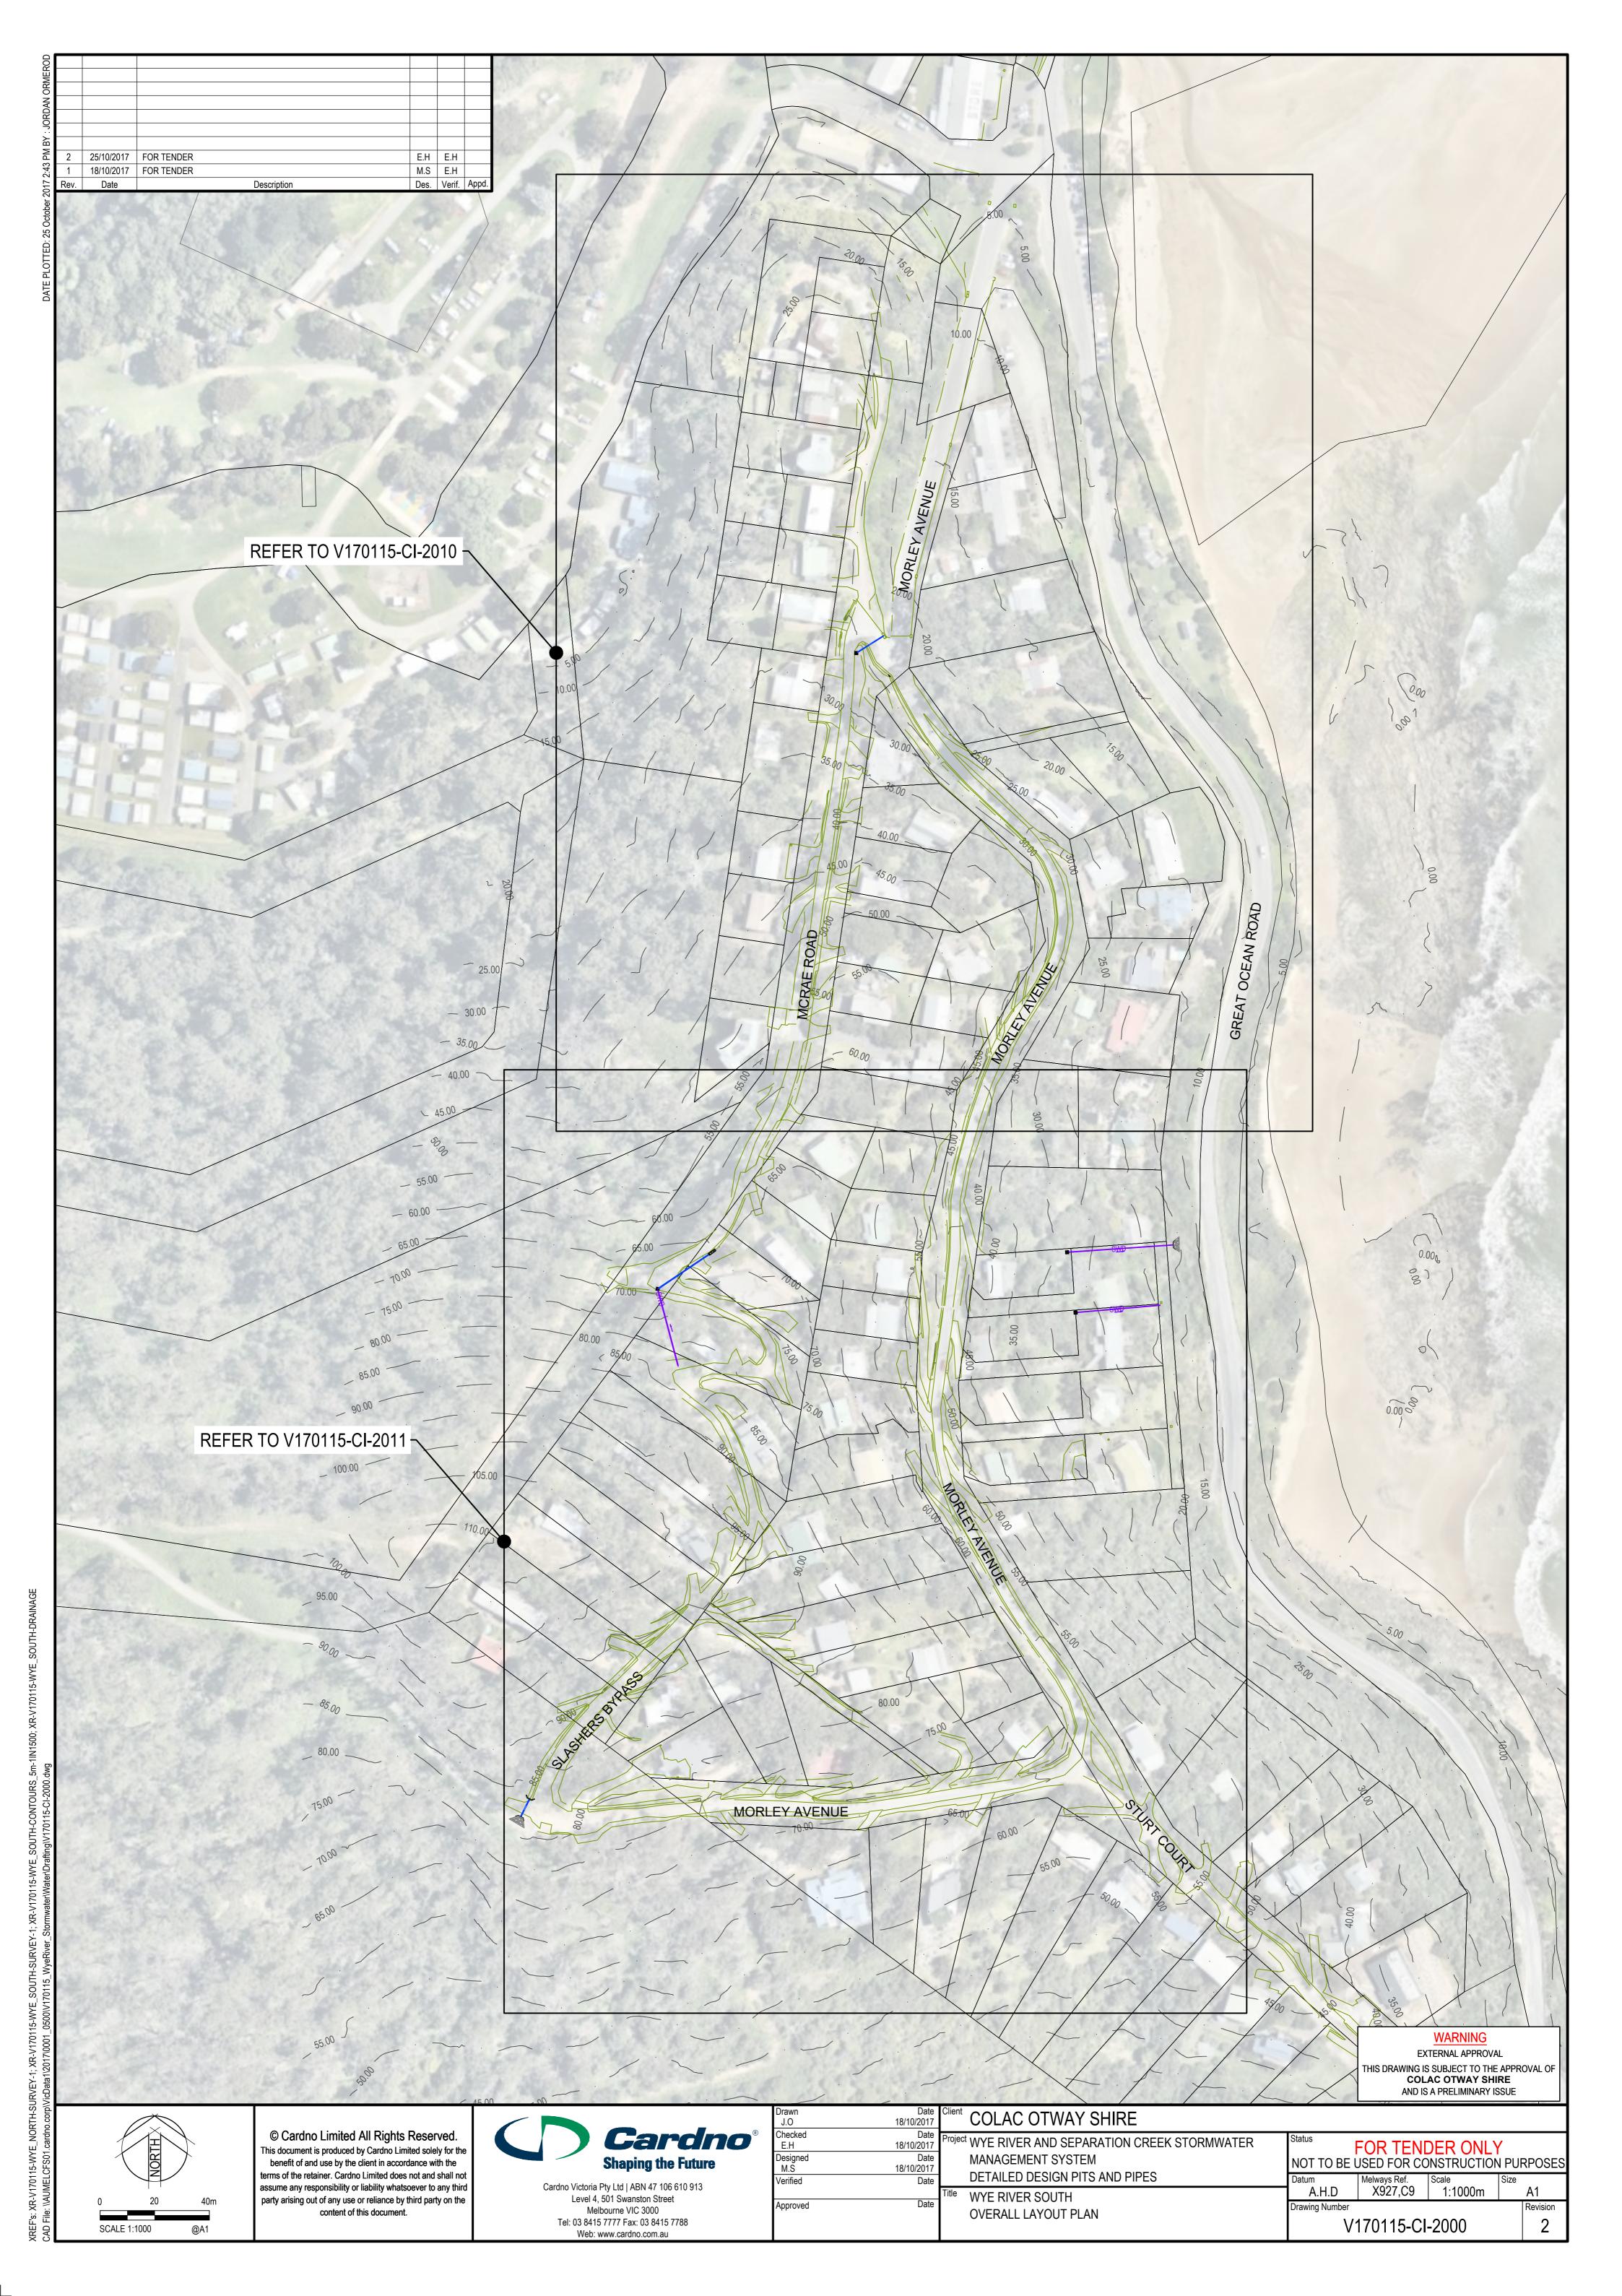



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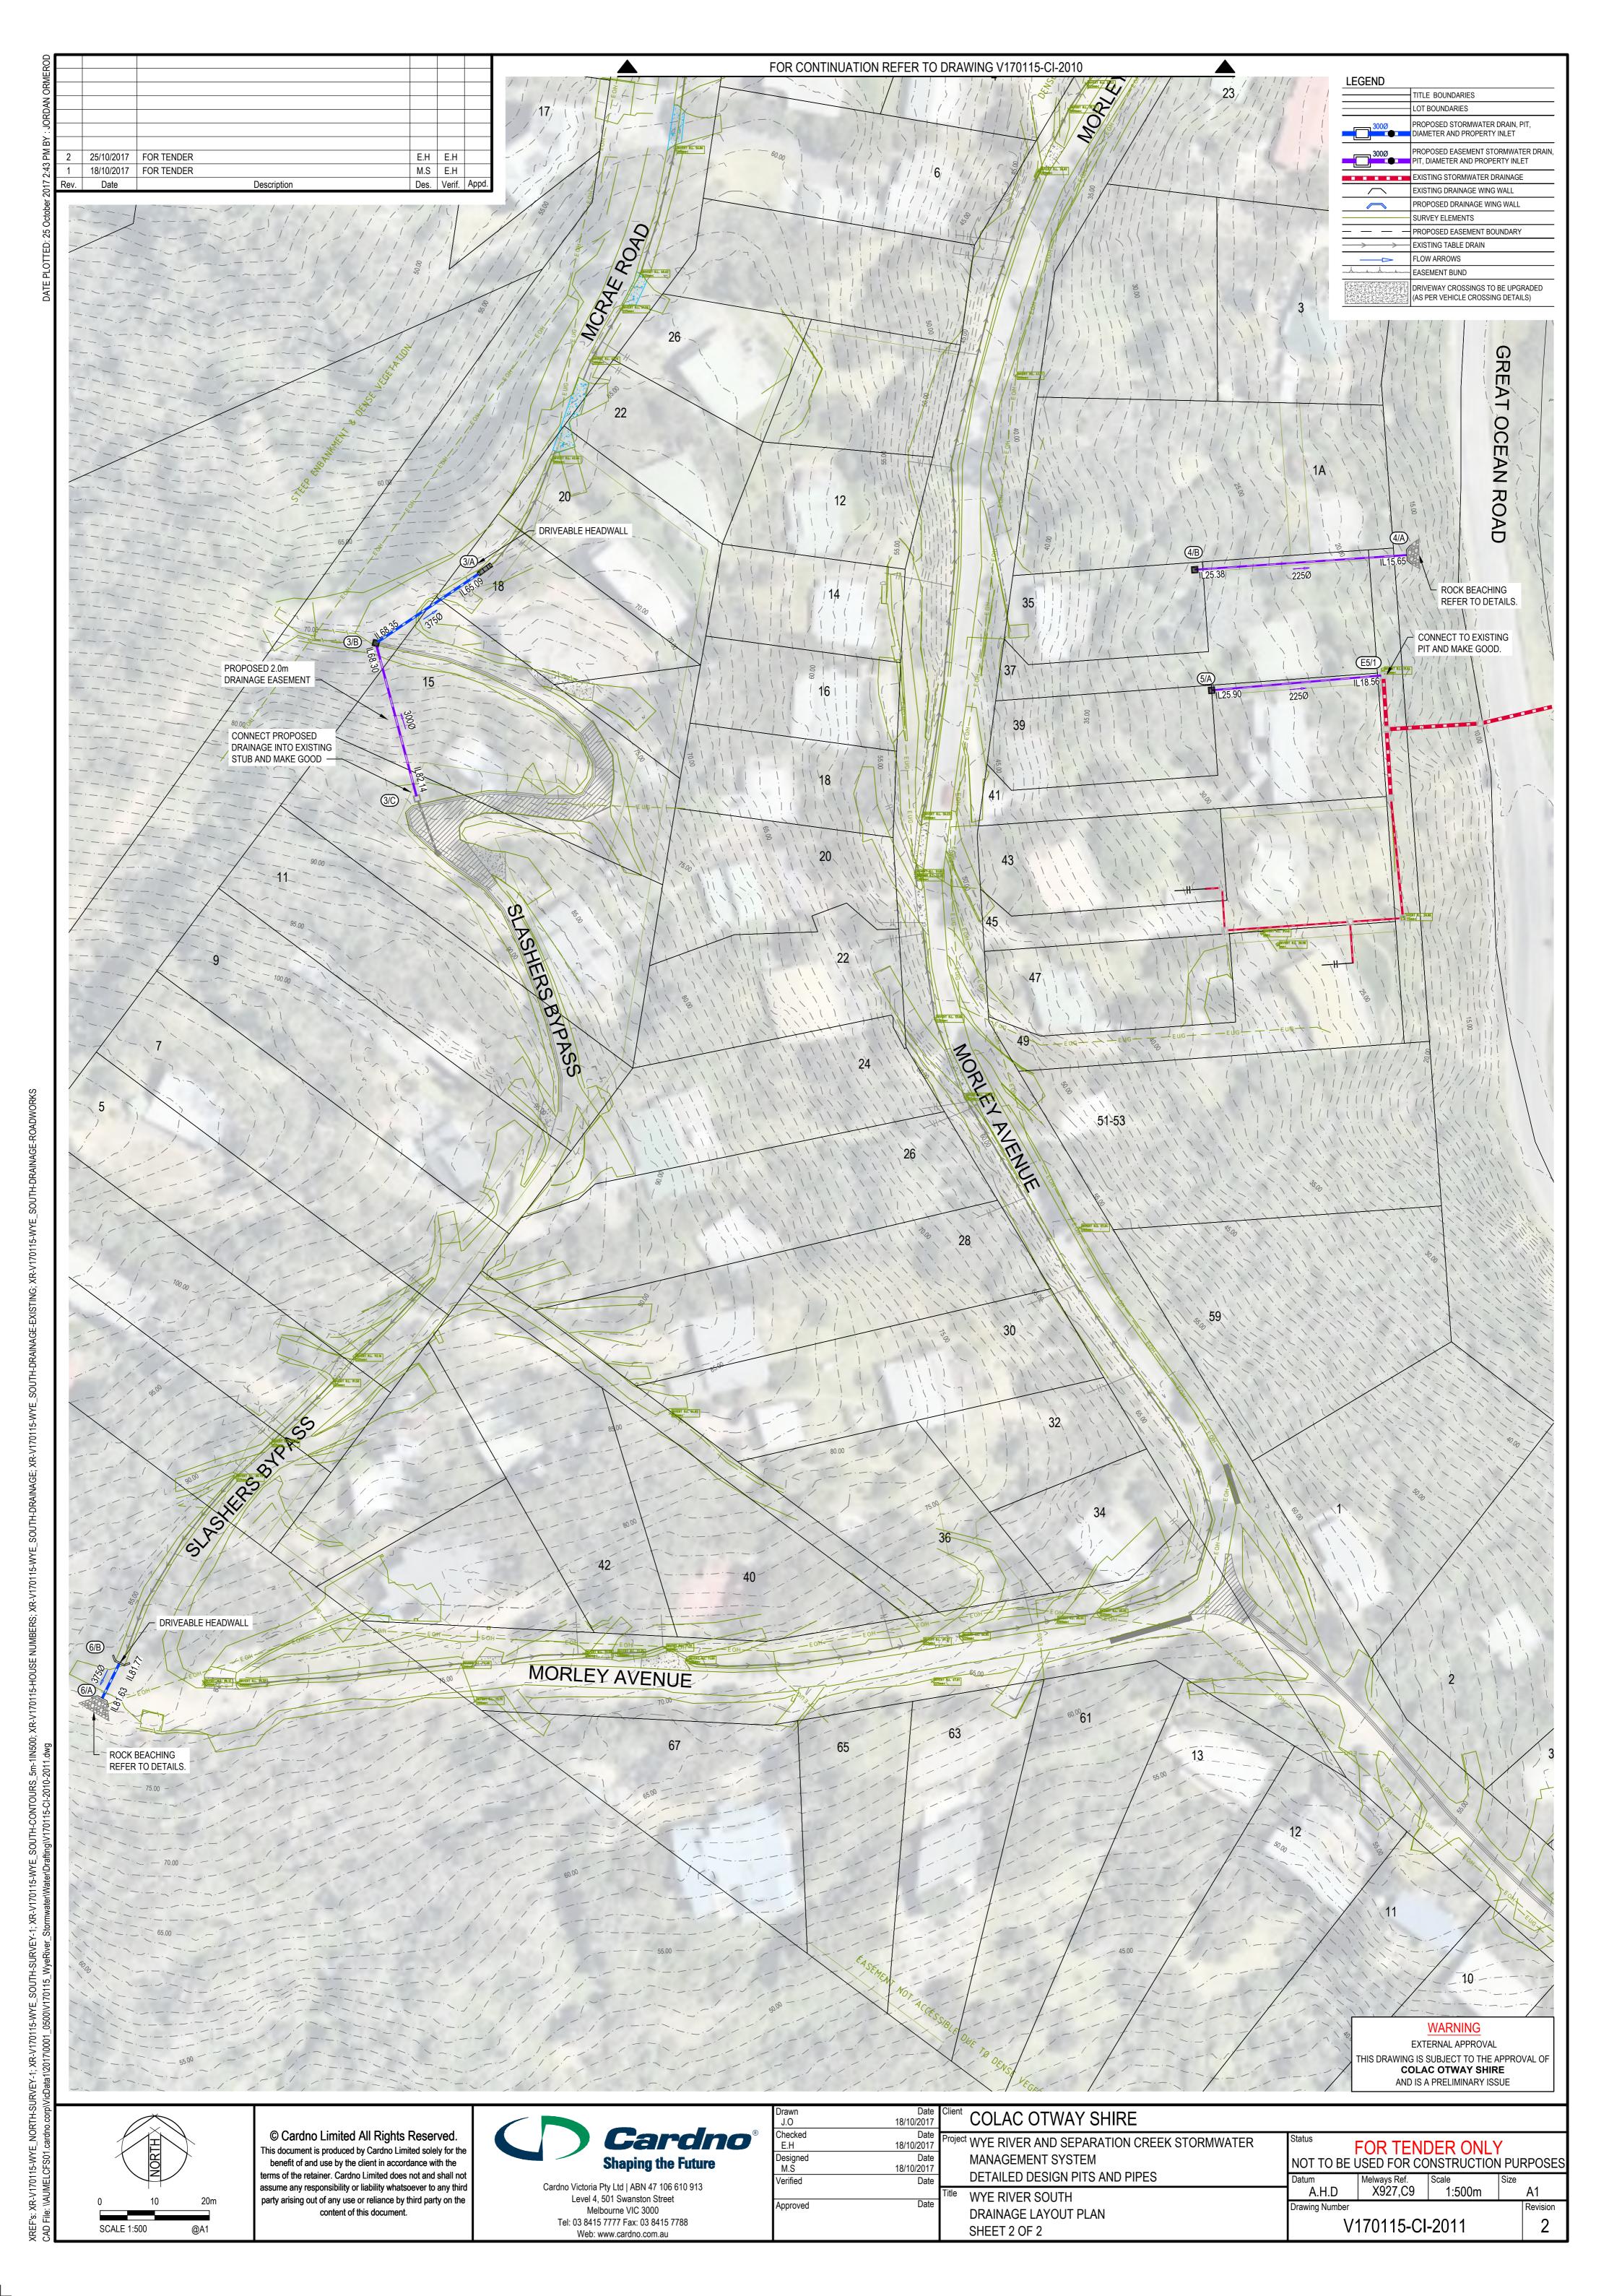
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ecked H	Date 18/10/2017	Project WYE RIVER AND SEPARATION CREE
signed P	Date 18/10/2017	MANAGEMENT SYSTEM
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proved	Date	DRAINAGE PIT DETAILS


COLAC OTWAY SHIRE					
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DETAILED DESIGN PITS AND PIPES	Datum	Melways Ref.	Scale	Size	
WYE RIVER NORTH	A.H.D	X927,C9		A1 Revision	
DRAINAGE PIT DETAILS	Drawing Number	mber			
SHEET 1 OF 2	V.	170115-CI	-1220	2	





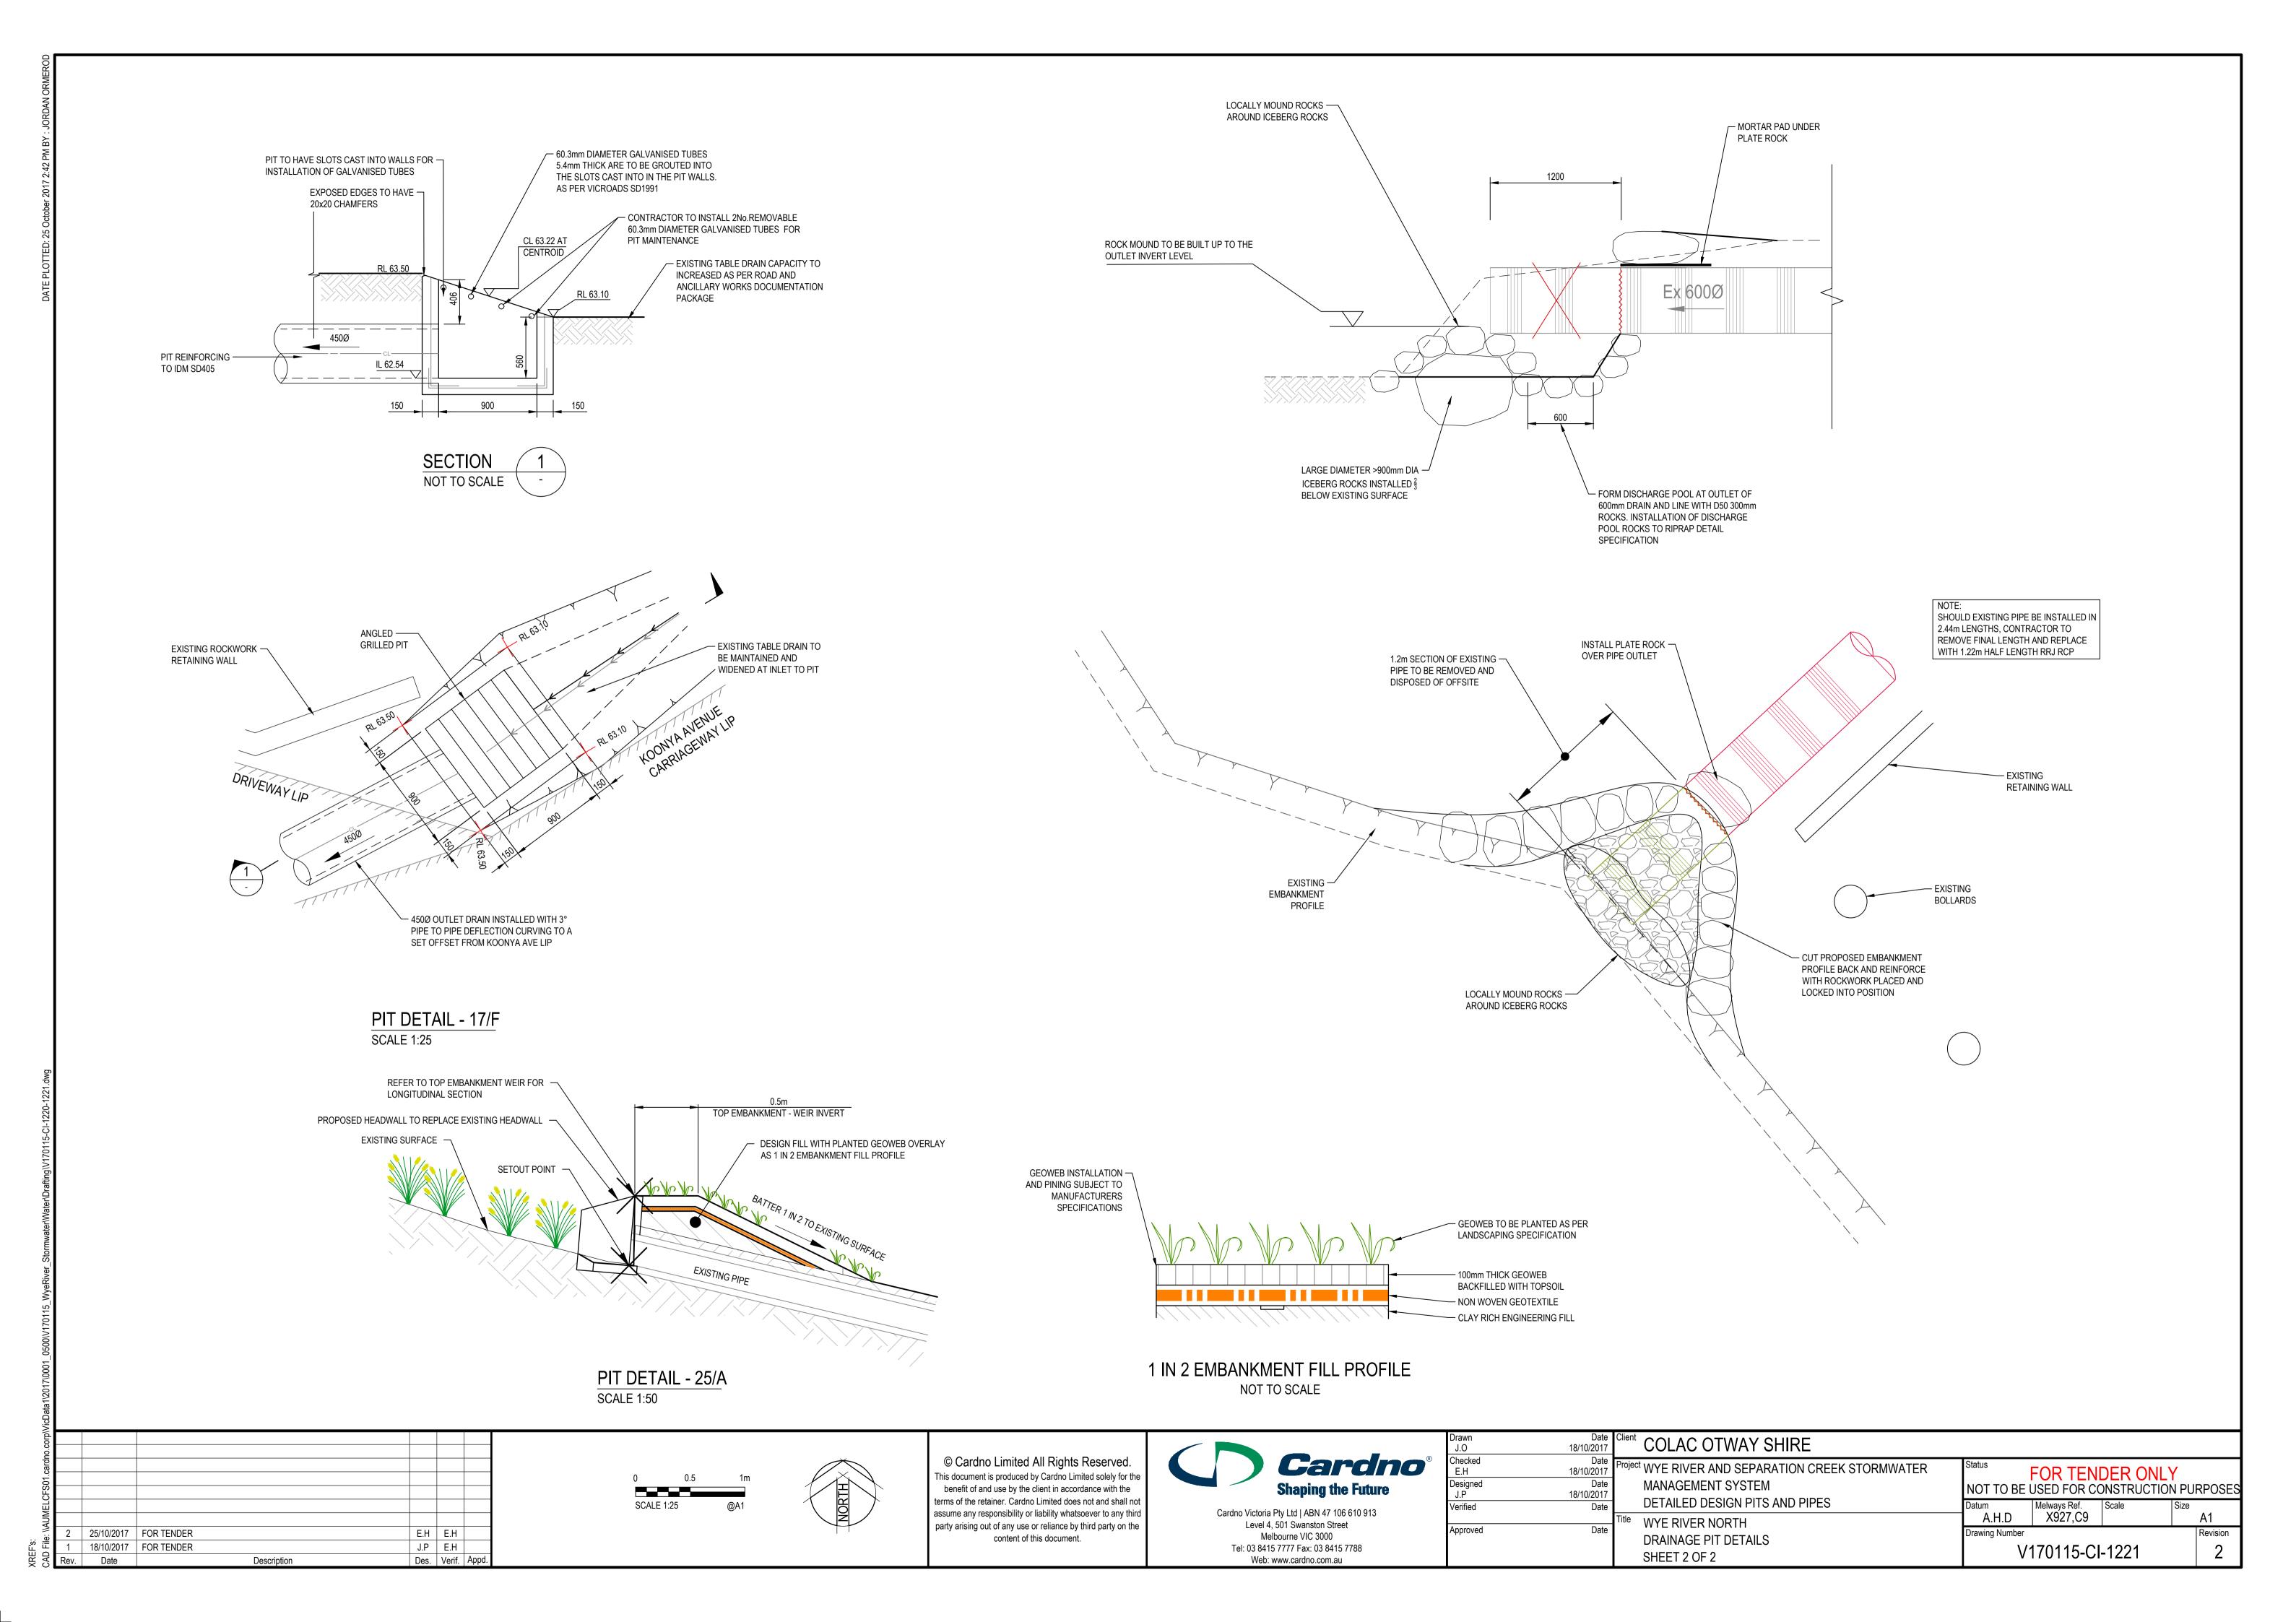

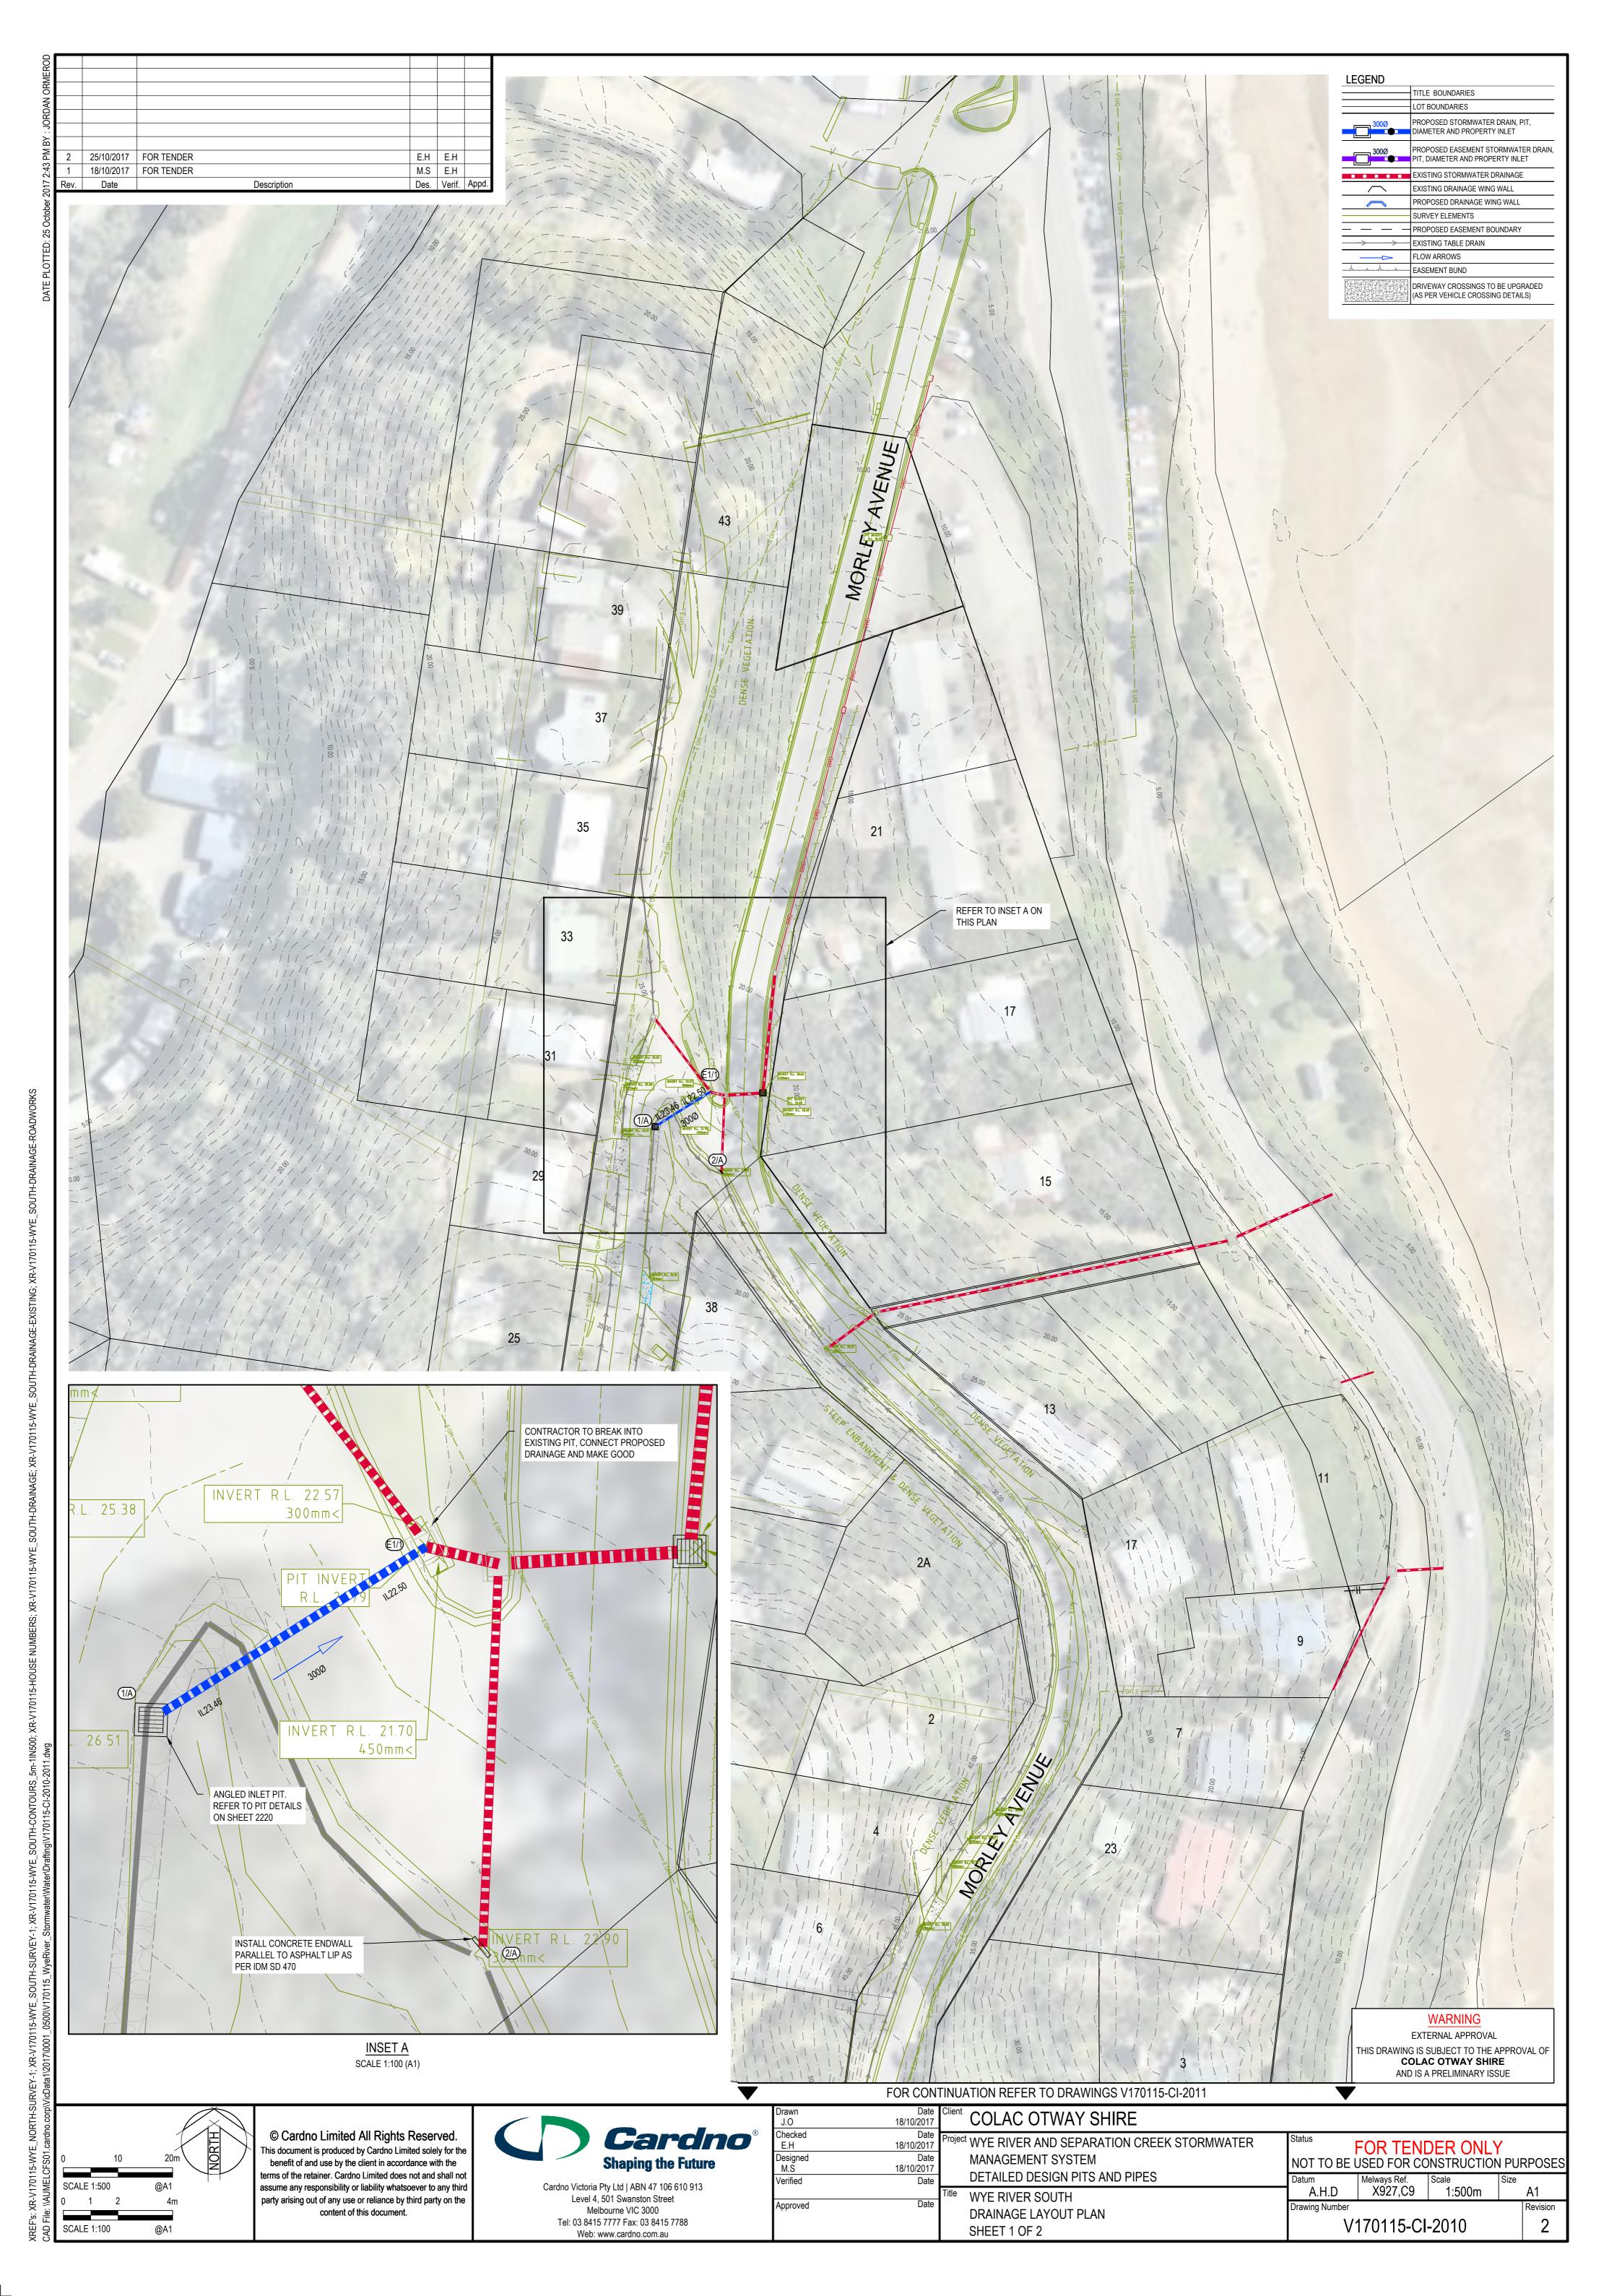


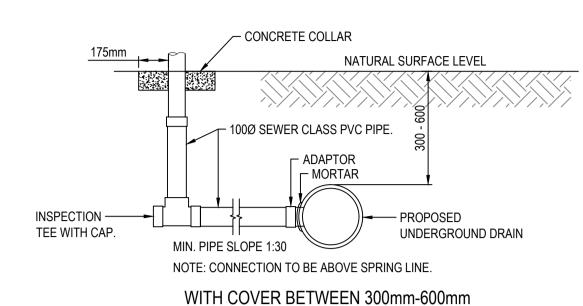

NATURAL SURFACE LEVEL TOP OF END CAP TO BE BURIED EXISTING HOUSE DRAIN — 300mm BELOW THE SURFACE. TO BE LOWERED LOCATION OF CAP TO BE MARKED REDUCER -BY A CHASE ON TOP OF KERB. 100Ø JUNCTION SP/SOC/SOC -∠ ADAPTOR 100Ø SEWER CLASS PVC -PIPE LENGTH TO SUIT ← MORTAR EXPANSION JOINT ADAPTOR -SOC/SP MORTARED TO PIPE PROPOSED UNDERGROUND DRAIN


WITH COVER GREATER THAN 600mm

PIPE TO PIPE CONNECTION DETAIL NOT TO SCALE

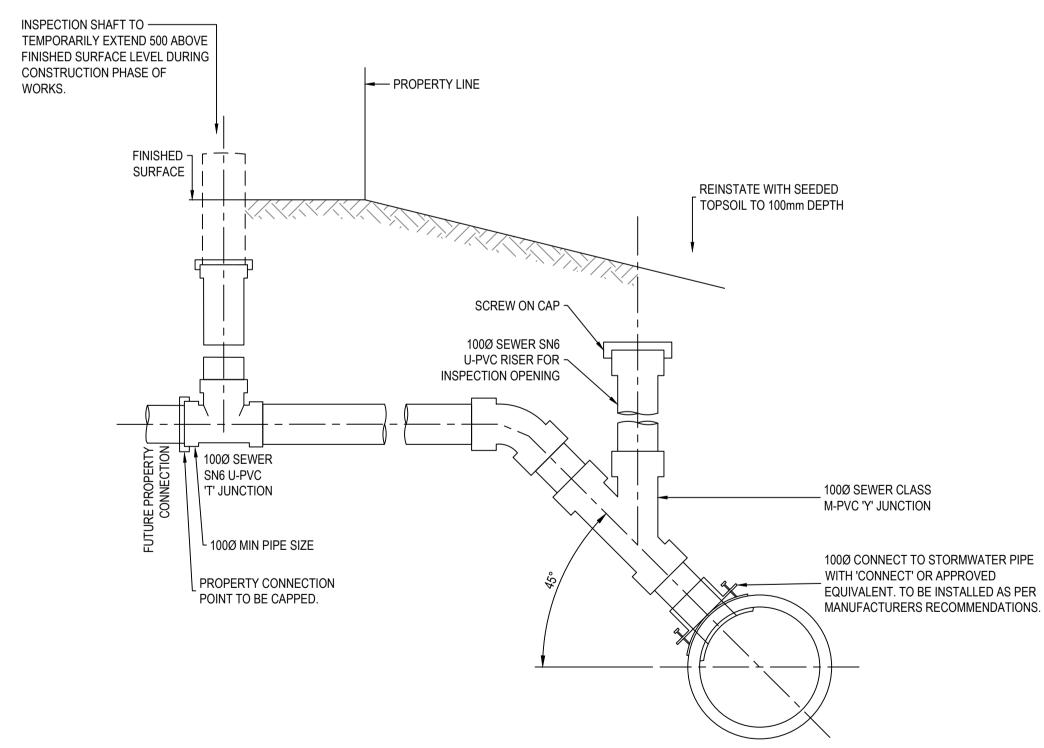

1. REFER TO PLUMBING CODE OF AUSTRALIA FOR ALL PIPE LAYING AND JOINTING REQUIREMENTS. TRUNK DRAIN CONNECTION

(45° TO PIPE WHERE COVER LIMITED OR STEEP GROUND) NOT TO SCALE

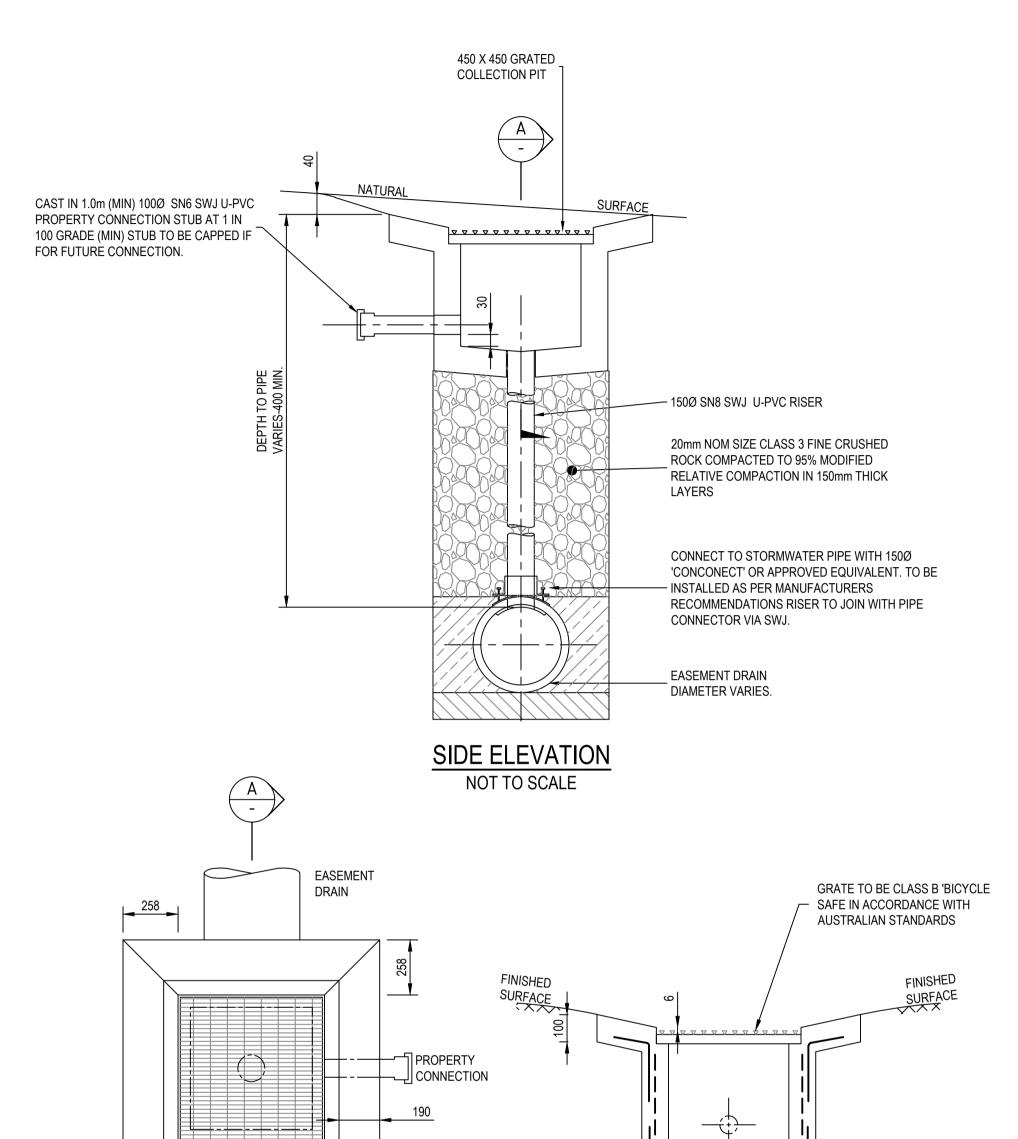

NOTES:

EDGE CONCRETE AROUND PERIMETER OF GRATE TOP OF GRATE 40mm (min) BELOW FINISHED SURFACE.

DO NOT BOND GRATE TO CONCRETE TO ALLOW EASY ACCESS TO PIT. CONCRETE TO BE SMOOTH TROWELLED FINISH.

SECTION A-A

NOT TO SCALE

GRATE FRAME TO BE OILED IF INSTALLED IN WET CONCRETE.

CONCRETE STRENGTH F'C = 25MPa. (MIN) AT 28 DAYS SEAL UP AND MAKE GOOD PIPE CONNECTION / INSERTION TO PIT.

8. PROPERTY CONNECTION MIN 100Ø PIPE AS PER CLAUSE 16.10.2 (PIPE DIAMETERS).

EASEMENT DRAIN CONNECTION - PITS

258

NOT TO SCALE

WARNING EXTERNAL APPROVAL THIS DRAWING IS SUBJECT TO THE APPROVAL OF **COLAC OTWAY SHIRE**

AND IS A PRELIMINARY ISSUE

25/10/2017 FOR TENDER E.H E.H 18/10/2017 FOR TENDER M.S E.H Date Description Des. Verif. Appd.

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EASEMENT

COLLECTION PIT - PLAN

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	E.H	18/10/2017
	Designed	Date
	M.S	18/10/2017
	Verified	Date
	Approved	Date


COLAC OTWAY SHIRE Diect WYE RIVER AND SEPARATION CREEK STORMWATER MANAGEMENT SYSTEM DETAILED DESIGN PITS AND PIPES WYE RIVER SOUTH

DRAINAGE TYPICALS


SHEET 1 OF 4

FOR TENDER ONLY NOT TO BE USED FOR CONSTRUCTION PURPOSES

X927,C9 AS SHOWN A1 V170115-CI-2100

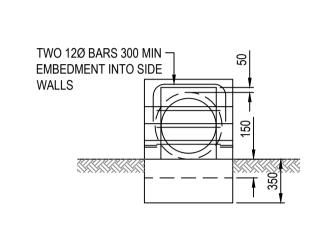



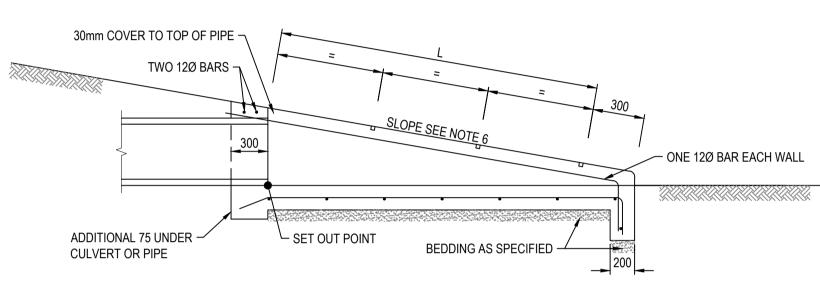

1. REINFORCEMENT, SL81 UNLESS OTHERWISE SPECIFIED, SHALL BE CONTINUOUS AROUND CORNERS AND LOCATED AS SHOWN.

CLEAR COVER 50 MIN. LAPS, FABRICS 300 MIN., BARS 25XBAR

2. DIAMETER MIN.

CONCRETE STRENGTH N32 AT 28 DAYS
 EXPOSED EDGES SHALL HAVE 20x20 CHAMFERS

5. RAILS WITHIN SECTION "L" SHALL BE EVENLY SPACED. THE MAXIMUM SPACING SHALL NOT EXCEED 600mm. 6. RAILS ARE 60.3mm DIAMETER GALVANIZED TUBES 5.4mm THICK. THESE ARE TO BE GROUTED INTO THE SLOTS IN THE WALLS.


SLOPE OF ENDWALL TO MATCH BATTER SLOPE MAXIMUM SLOPE 4 TO 1.


		-			
					DIRECTION OF TRAFFIC
RAILS, SEE NOTE 6 —					
150	_	-	- Pl	/ _/	150 \N

'L' (mm)	TOTAL NUMBE OF RAILS					
100-600	1					
601-1200	2					
1201-1800	3					
1801-2400	4					

DRIVEABLE ENDWALL TYPE 1

NOT TO SCALE

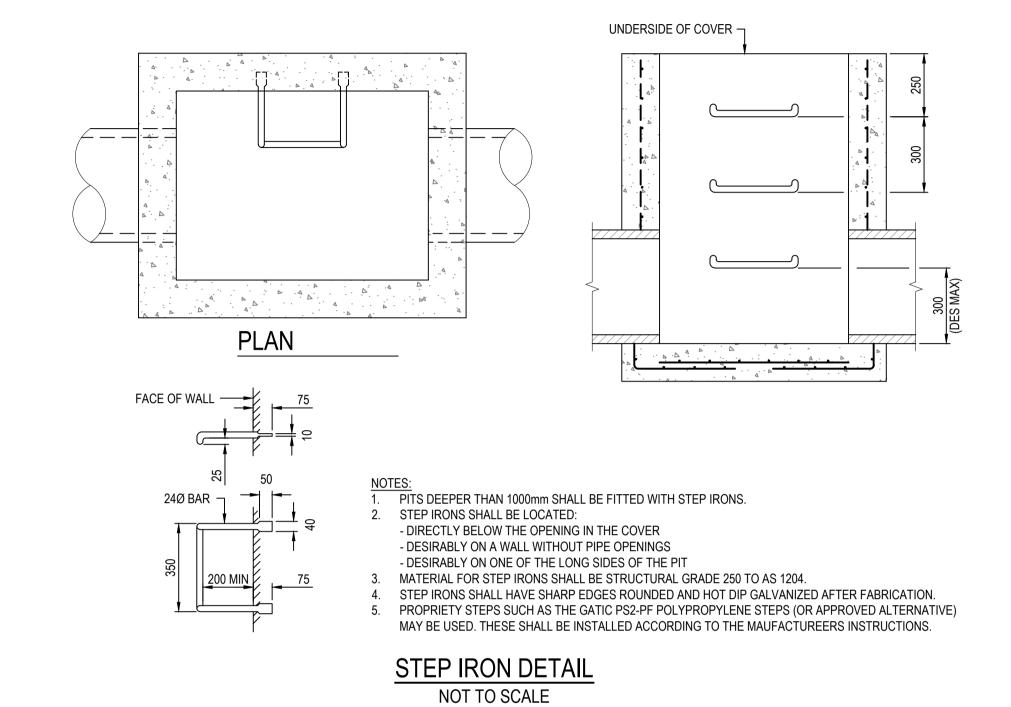

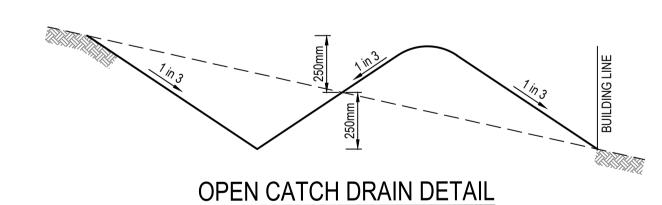

NOT TO SCALE NOTE: CATCH DRAINS TO BE GRADED TO NOMINATED OUTLETS. FINISH WITH 100mm TOPSOIL

> WARNING EXTERNAL APPROVAL THIS DRAWING IS SUBJECT TO THE APPROVAL OF **COLAC OTWAY SHIRE** AND IS A PRELIMINARY ISSUE

25/10/2017 FOR TENDER E.H E.H 18/10/2017 FOR TENDER M.S E.H

Description

Des. Verif. Appd.

Date

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)	Checked E.H	Date 18/10/2017	Ī
	Designed M.S	Date 18/10/2017	
	Verified	Date	
	Approved	Date	

2017	Client	COLAC OTWAY SHIRE
Date 2017	Project	WYE RIVER AND SEPARATION CREEK STORMWA
Date 2017		MANAGEMENT SYSTEM
Date		DETAILED DESIGN PITS AND PIPES
Date	Title	WYE RIVER SOUTH
Jale		DRAINAGE TYPICALS

SHEET 2 OF 4

	· ·	• · · · — · · ·	DER ONLY	•	RPOSES
PIPES		Melways Ref.	Scale	Size	
	A.H.D	X927,C9	AS SHOWN		A1
	Drawing Number				Revision
	V1	170115-CI	-2101		2

COMPRESSIBLE MEMBRANE AROUND PIPES. (SEE NOTE 6)

15% > PIPE GRADE > 50%

CONCRETE BULKHEAD FOR RCP DETAIL

NOT TO SCALE

- 1. BULKHEADS ARE REQUIRED FOR PIPES 300mm DIAMETER OR
- 2. BULKHEAD TO BE LOCATED DIRECTLY BEHIND DOWNSTREAM OF COLLAR SO AS NOT TO ENCASE THE JOINT
- 3. LOCATE BULKHEAD AT A RETAINING WALL UNDER THE WALL.
- 4. KEY CONCRETE BULKHEADS INTO SIDES AND BOTTOM OF TRENCH AGAINST A BEARING SURFACE OF UNDISTURBED SOIL
- CONCRETE TO BE CLASS N25
- DO NOT DEFORM PIPES DURING PLACEMENT OF CONCRETE
- PROVIDE CONTINUOUS DRAINAGE PATH THROUGH BULKHEADS 8. COMPRESSIBLE MEMBRANE AROUND PIPE TO BE 3 THICK RUBBER FOR
- BULKHEADS ON SLOPES


- PIPE BEDDING AND BACKFILL


REQUIREMENTS. REFER TO

SUBJECT TO TRENCHING


PIPE TRENCH DETAILS

- 9. GROUNDWATER DRAIN THROUGH BULKHEAD IS NOT REQUIRED WHEREVER BACKFILL IS CEMENT TREATED
- 10. GROUNDWATER DRAINS THROUGH BULKHEADS SHALL BE FILLED WITH FIBREGLASS WOOL OR OTHER APPROVED FILTER MATERIAL
- 11. BULKHEADS SHALL BE CONSTRUCTED AT EVERY SECOND JOINT WHERE PIPE GRADES EXCEED 15% (1 in 6.7) AND CEMENT TREATED BACKFILL IS NOT SPECIFIED. REFER TYPICAL DETAIL

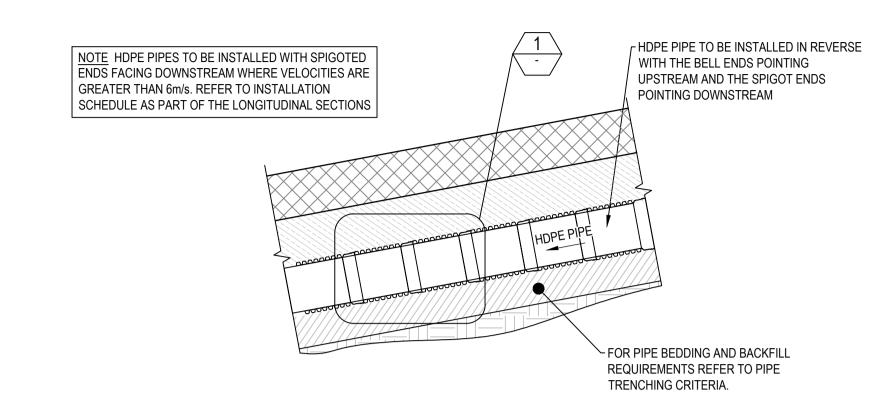


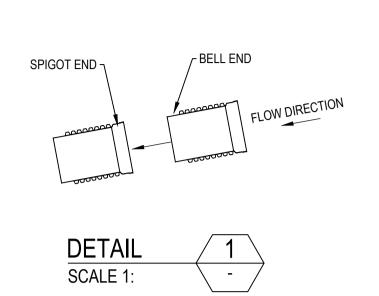



HIGH VELOCITY HDPE PIPE INSTALLATION DETAIL NOT TO SCALE

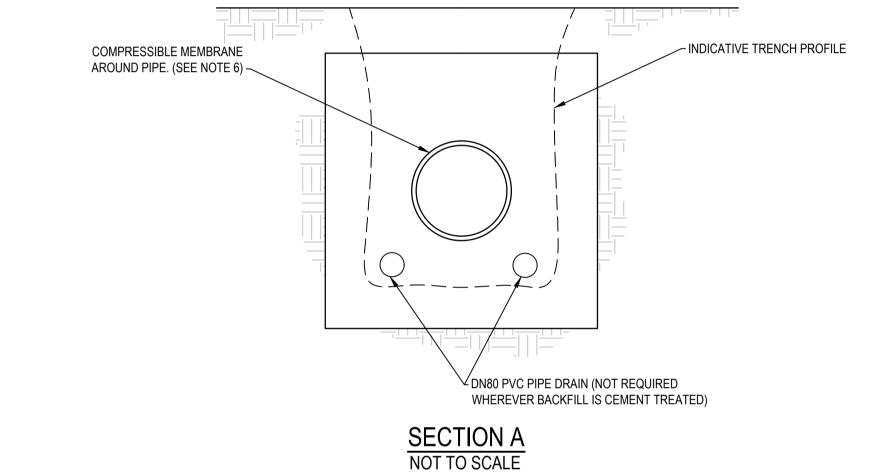

PLANT S	PLANT SCHEDULE FOR SLOPES STEEPER THAN 1 IN 2					
BOTANICAL NAME	COMMON NAME	PLANT DENSITY	NOTES			
GOODENIA OVATA	HOP GOODENIA	1 -2 PLANTS PER 50m2	DISPERSED PLANTING AND PLANT AT TOP OF BANKS/TRANSITION BETWEEN ROAD AND PIPE TRENCH			
CORREA ALBA	WHITE CORREA	1 -2 PLANTS PER 50m2	DISPERSED PLANTING AND IMMEDIATELY UPSTREAM OF PITS			
POA POAFORMIS	COAST TUSSOCK-GRASS	5 PLANTS PER 5m2	PLANT IN CLUMPS OF 5			
LOMANDRA LONGFOLIA	MAT RUSH	1 -2 PLANTS PER 50m2	DISPERSED PLANTING			
ENCHYLAENA TOMENTOSA	RUBY SALTBUSH	1 -2 PLANTS PER 50m2	DISPERSED PLANTING			
MICROLAENA STIPOIDES	WEEPING GRASS	10g/m2	BEGIN WITH A WEED FREE SEED BED. SOW SEED 10-15mm BELOW THE SOIL SURFACE			

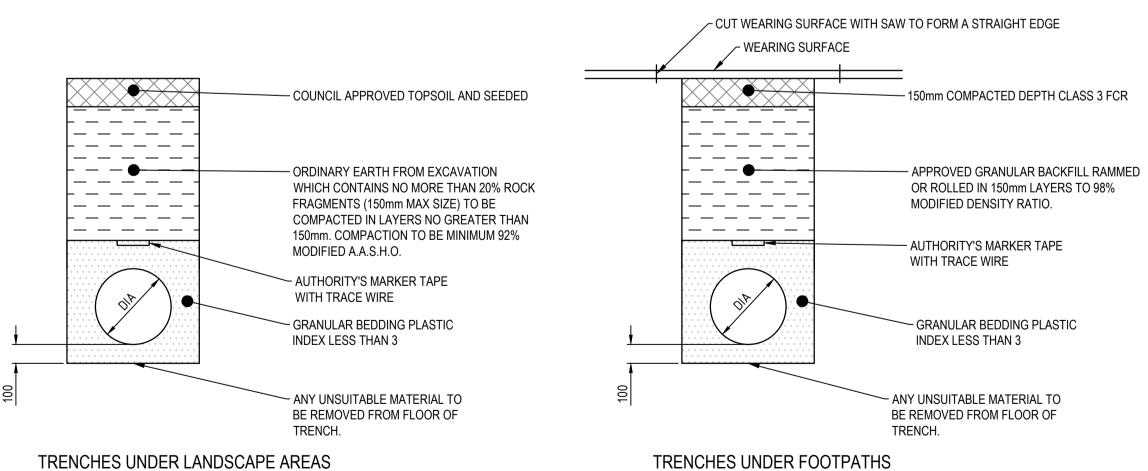

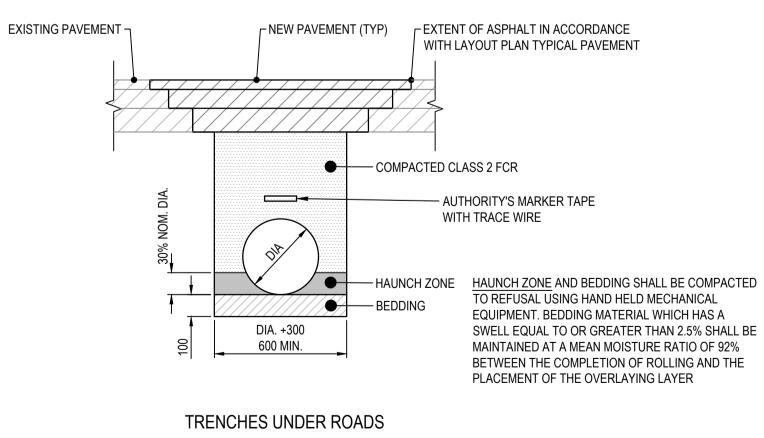

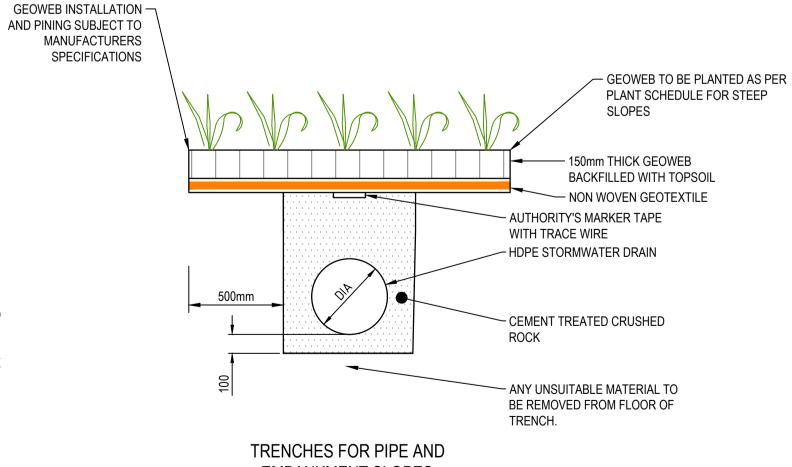

PIPE TRENCH DETAILS NOT TO SCALE

EMBANKMENT SLOPES STEEPER THAN 1 IN 2 WARNING EXTERNAL APPROVAL THIS DRAWING IS SUBJECT TO THE APPROVAL OF

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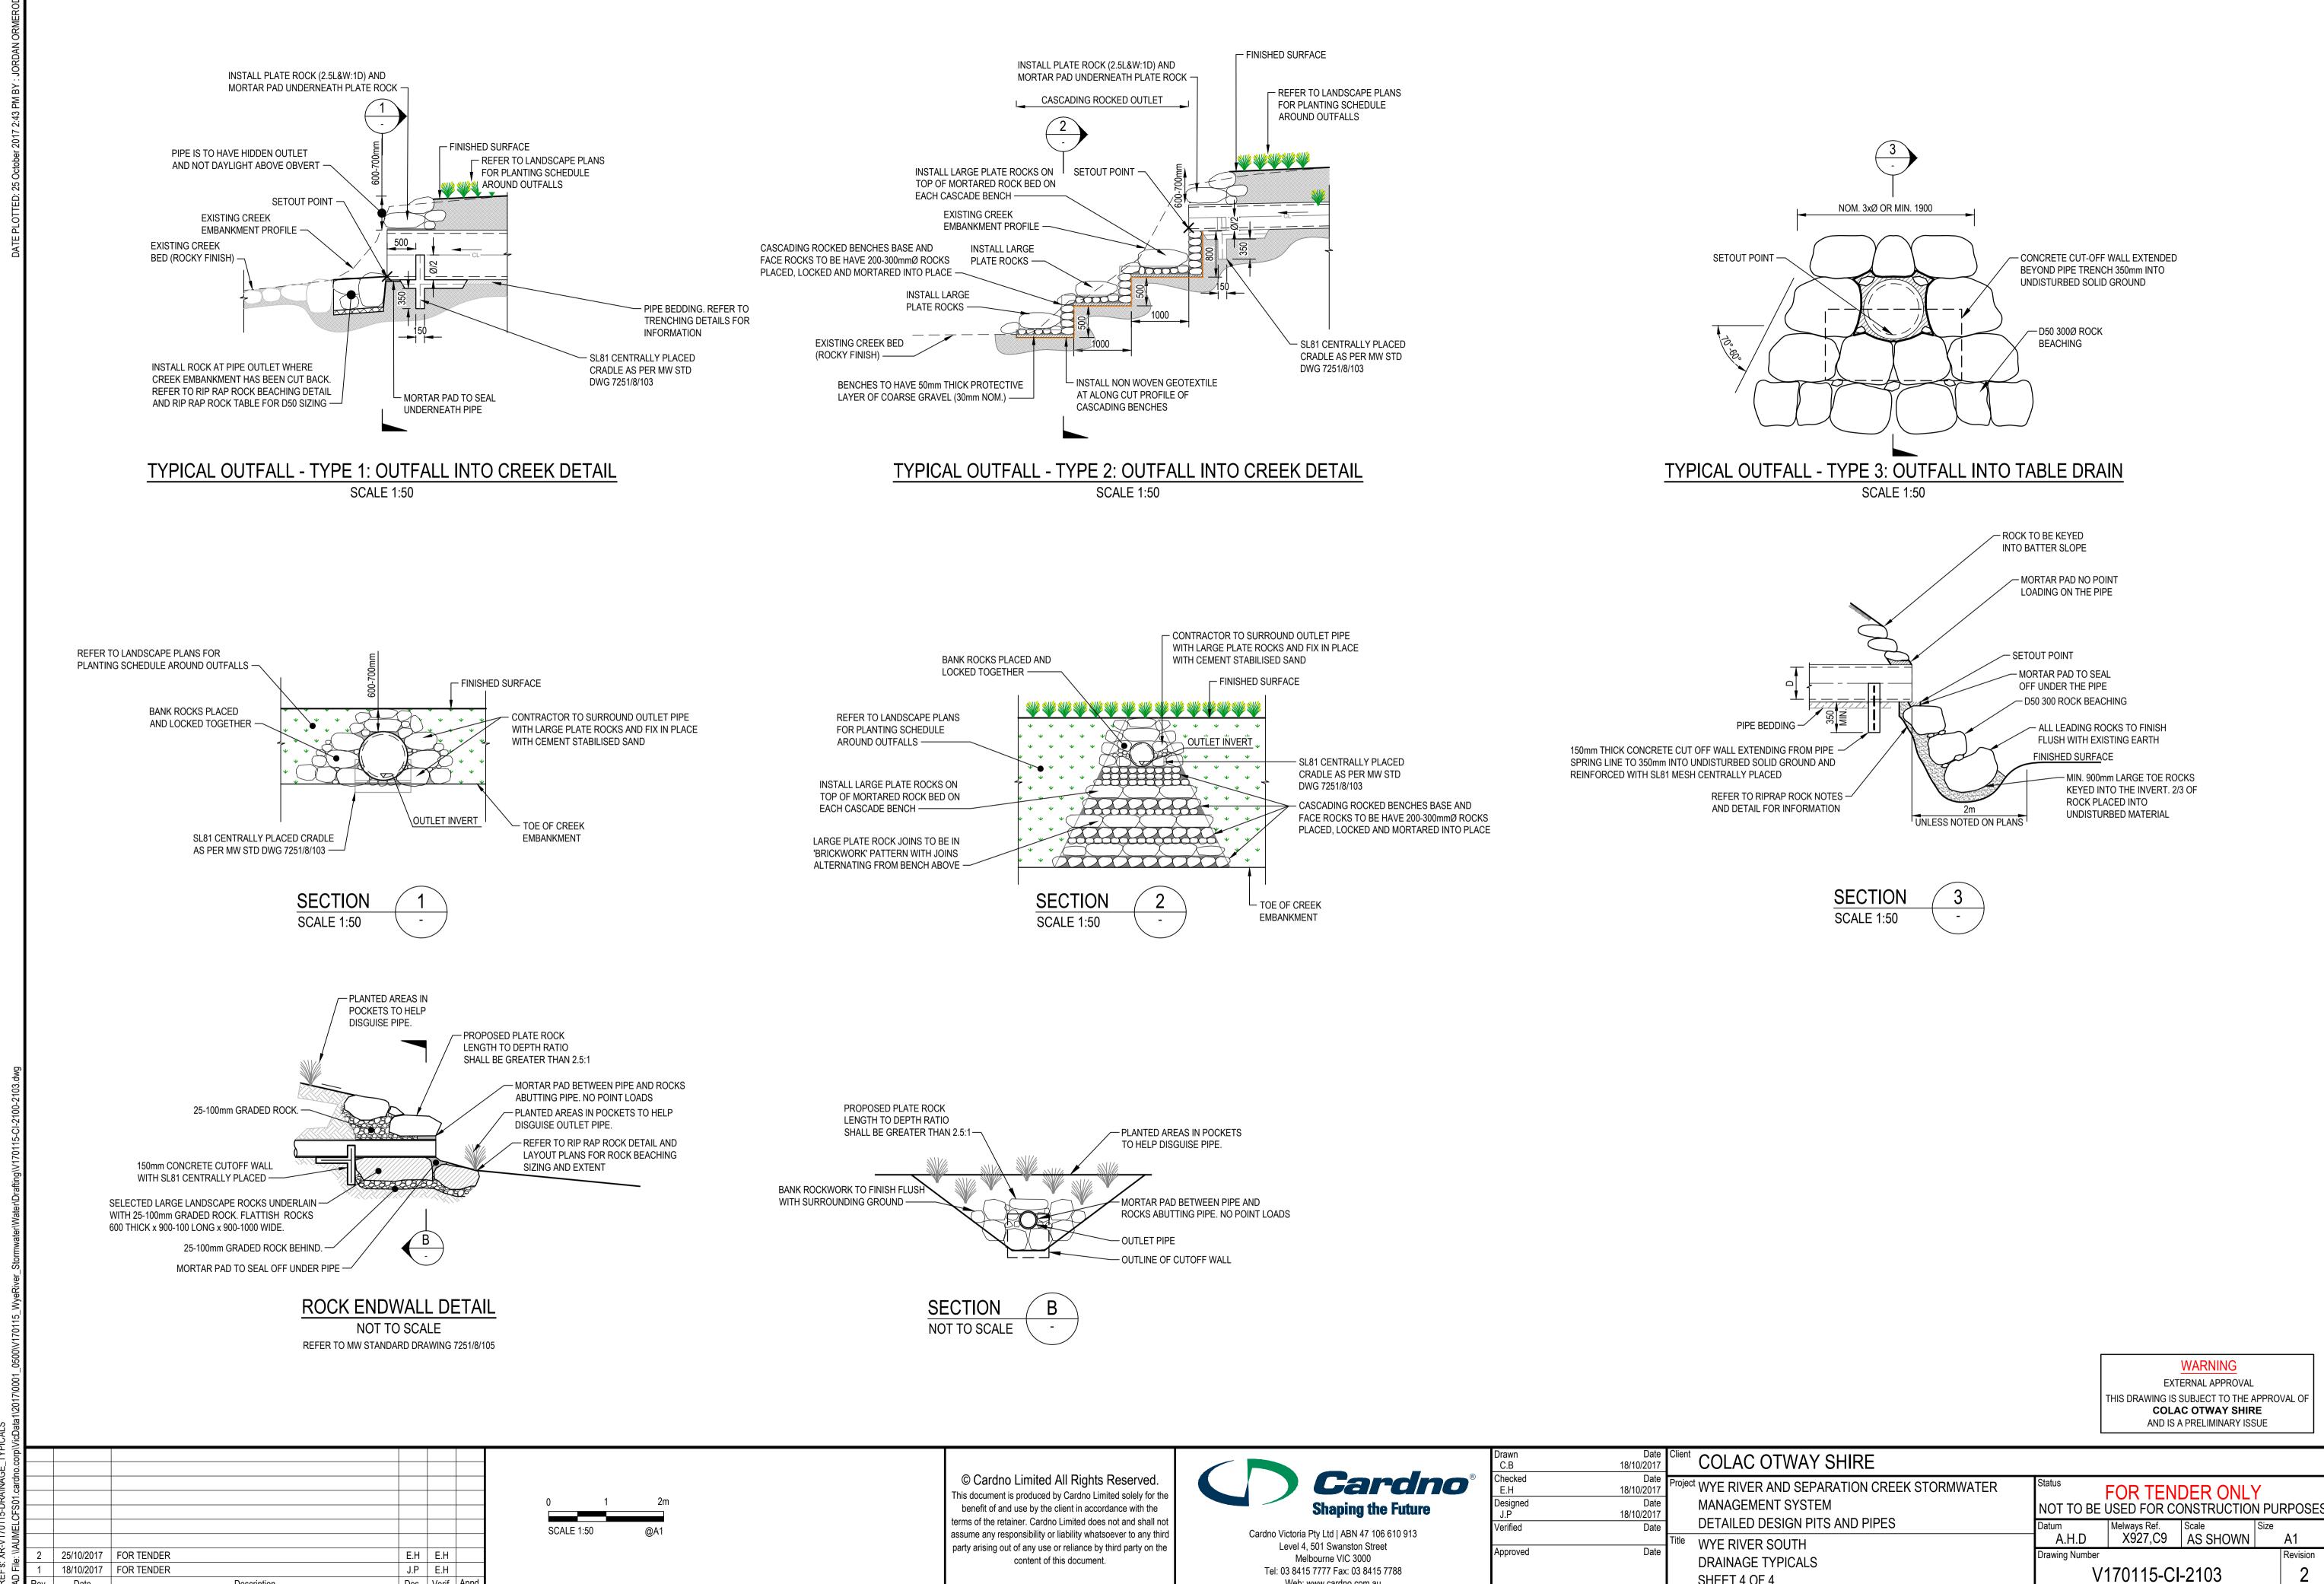
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Client	COLAC OTWAY SHIRE
Project	WYE RIVER AND SEPARATION CREEK STORMWATER
	MANAGEMENT SYSTEM
	DETAILED DESIGN PITS AND PIPES
Title	WYE RIVER SOUTH

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	Drawing Number				Revision

COLAC OTWAY SHIRE AND IS A PRELIMINARY ISSUE

WIERIVER SOUTH DRAINAGE TYPICALS V170115-CI-2102 SHEET 3 OF 4



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SHEET 4 OF 4

Date

Description

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LEGEND — — — EXISTING SURFACE DESIGN SURFACE — · — · — DRAINAGE HYDRAULIC GRADE LINE (HGL) PROPOSED DRAINAGE EXISTING DRAINAGE SUPPLEMENTARY DRAINAGE 2/A PIT NUMBER FINE CRUSHED ROCK BACKFILL (FCR) UNDER EX ROADS CEMENT TREATED BACKFILL FOR STEEP SLOPES CONTRACTOR TO VERIFY EXISTING SERVICES CONNECTION LEVELS PRIOR TO CONSTRUCTION. ANY DISCREPANCIES MUST BE IMMEDIATELY IDENTIFIED AND THE SUPERINTENDENT NOTIFIED PRIOR TO CONSTRUCTION COMMENCING. A1 Revision

TO BE CONSTRUCTED AS PART OF ROADWORKS (3/C) (3/D) 0.366 0.070 0.664 0.017 0.225 0.018 0.217 < 0.066 0.248 0.086 0.715 DESIGN FLOW (m3/s) CAPACITY (m3/s) 0.241 5.18 6.09 2.96 3.34 1.90 ACTUAL VELOCITY (m/s) 4.15 3.32 2.25 3.90 3.41 FULL VELOCITY (m/s) 6.59 9.39 5.65 5.45 375 RCP (RRJ) - Class 4 300 PIPE SIZE (mm) 225 RCP (RRJ) PIPE TYPE RCP (RRJ) - Class 4 RCP (RRJ) PE RCP (RRJ) RCP (RRJ) 1 in 50 GRADE 1 in 12.3 1 in 2.1 1 in 6.9 1 in 16.1 1 in 4 1 in 4.3 37.0 45.0 DATUM RL (AHD) -13.0 -15.0 -15.0 22.800 15.692 15.692 68.564 68.644 82.346 82.751 0.725 0.773 0.773 DEPTH TO INVERT 68.349 68.300 68.300 INVERT LEVEL 21.700 **82.140** 82.640 18.557 18.557 81.627 DESIGN SURFACE **EXISTING SURFACE** LENGTH, CHAINAGE 22.64 29.42 11.89 11.09 31.56 31.56

SCALE H:1:500 V:1:250 @A1

E.H E.H

M.S E.H

Des. Verif. Appd.

25/10/2017 FOR TENDER

18/10/2017 FOR TENDER

Description

Date

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esigned M.S	Date 18/10/2017	MANAGEMENT SYSTEM
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Date 18/10/2017	COLAC OTWAY SHIRE	
Date 18/10/2017	Project WYE RIVER AND SEPARATION CREEK STORMWATER	(
Date	MANAGEMENT SYSTEM	
18/10/2017 Date	DETAILED DESIGN PITS AND PIPES	Ī
Dete	Title WYE RIVER SOUTH	
Date	DRAINAGE LONGSECTIONS	Į!

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	PIT SCHEDULE												
DIT NO	LOCA	ATION	TVDE	INTE	RNAL	PIT COVER CLASS (AS D		DEDTU	INL	_ET	OU	ΓLET	COMMENTS
PIT NO	EASTING	NORTHING	TYPE	WD	LEN	LEVEL	3996) DEPTH		DIA	INV LEV	DIA	INV LEV	COMMENTS
1/A	751557.936	5719583.347	GEP	900	900	25.975	-	2.51			300	23.465	900 X 900 CUSTOM ANGLED GRILL. CLASS D COVER. REFER TYPICAL DETAIL
3/A	751503.966	5719363.059	DEW	-	-	-	-	-	375	65.089			DRIVABLE ENDWALL. REFER TO DRAINAGE TYPICAL DETAILS
3/B	751485.204	5719350.395	GEP	900	600	69.073	D	0.73	300	68.300	375	68.349	REFER IDM SD 480
4/A	751673.982	5719366.532	EW	-	-	-	-	-	225	15.650			REFER IDM SD 465
4/B	751635.150	5719363.845	GEP	500	0	28.733	В	3.35			225	25.381	EASEMENT INLET GRATED PIT. REFER DRAINAGE TYPICAL DETAILS
5/A	751638.247	5719341.764	GEP	500	0	26.898	В	1.00			225	25.897	EASEMENT INLET GRATED PIT. REFER DRAINAGE TYPICAL DETAILS
6/A	751435.085	5719157.184	HW	-	-	-		-	375	81.627			REFER IDM SD 465
6/B	751438.219	5719163.519	HW	-	-	-		-			375	81.768	REFER IDM SD 465


<u>NOTES:</u>

- 1. ALL PITS ARE TO BE TO IDM STANDARDS UNLESS NOTED OTHERWISE.
- 2. PITS DEEPER THAN 1.00m SHALL BE FITTED WITH STEPIRONS, FIRST STEPIRON TO BE 300mm FROM THE BOTTOM OF THE PIT.
- 3. COVER LEVELS TO BE SET TO MATCH THE FINISHED SURFACE PROFILES AND ADJACENT CONSTRUCTION.
- 4. GP = GRATED PIT, GSEP = SIDE ENTRY PIT GRATED, DGSEP = DOUBLE SIDE ENTRY PIT GRATED, SEP = SIDE ENTRY PIT, DSEP = DOUBLE SIDE ENTRY PIT, JP = JUNCTION PIT, EP = END OF PIPE, EW = ENDWALL, DEW = DRIVEABLE ENDWALL.
- 5. UNLESS OTHERWISE SPECIFIED, PIT TYPES REFER TO IDM STANDARD DRAWINGS
 - FIGURE SD 405 UNHAUNCHED PITS (450Ø MAX. PIPE)
 FIGURE SD 410 HAUNCHED PITS (MIN 525Ø PIPE)
 - FIGURE SD 420 JUNCTION PIT IN ROAD RESERVE
 - FIGURE SD 426 JUNCTION PIT WITH NON-CONCRETE COVER (NON TRAFFICABLE AREAS)
 - FIGURE SD 426 JUNCTION PIT WITH NON-CONCRETE COVER (NON TRAPPICABLE AREAS)
 FIGURE SD 441 GRATED SIDE ENTRY PIT WITH LIGHTWEIGHT COVER & CONCRETE SURROUND FOR 'SM2-M'
 - FIGURE SD 455 DEPRESSED GRATED PIT
 FIGURE SD 460 INLET CATCH PIT
 - FIGURE SD 460 INLET CATCH PIT
 FIGURE SD 465 REINFORCED CONCRETE WINGWALL (IN-SITU)
 - FIGURE SD 465 REINFORCED CONCRETE WINGWALL (IN-STIU)
 FIGURE SD 470 CONCRETE ENDWALL FOR PIPES UP TO 300mmØ (WALKWAYS, PATHS AND TRACKS)
 - FIGURE SD 480 GRATED PIT FOR SM2 MODIFIED KERB & CHANNEL
 FIGURE SD 481 ALTERNATE CRATED BIT FOR SM2 MODIFIED KERB & CHANNEL ISM2 MILLIPSTREAM BIT ONLY
 - FIGURE SD 481 ALTERNATE GRATED PIT FOR SM2 MODIFIED KERB & CHANNEL 'SM2-M' UPSTREAM PIT ONLY
 FIGURE SD 496 MODIFIED EXISTING PIT TO GRATED PIT IN VEHICLE CROSSING / LAYBACK

 FIGURE SD 496 MODIFIED EXISTING PIT TO GRATED PIT IN VEHICLE CROSSING / LAYBACK
- FIGURE SD 496 MODIFIED EXISTING PIT TO GRATED PIT IN VEHICLE CROSSING / LAYBACK
 FOR HAUNCHED PITS REFER TO IDM STANDARD DRAWING FIGURE SD 410. PITS TO BE HAUNCHED TO COUNCIL STANDARD OPENINGS.
- 7. STUBS AND PIPE ENDS TO BE BLOCKED OFF TO COUNCIL'S SATISFACTION.
- 8. ALL GRATED PITS TO HAVE BICYCLE SAFE LOCKDOWN GRATES.
 9. ALL GRATED SIDE-ENTRY PITS TO HAVE MIN 100mm THICK CONCRETE APRON BETWEEN GRATE AND ASPHALT. REFER IDM STANDARD DRAWINGS.
- 10. PITS WITHIN ROAD PAVEMENT, VEHICLE CROSSINGS OR WITHIN 0.75m OF A VEHICLE CROSSING, TO HAVE CLASS D CAST IRON LOCK DOWN LIDS, LID INFILL COLOURED TO MATCH ROAD
- SURFACE.

 11. ALL PITS WITHIN ROAD TO BE CONSTRUCTED WITH 32 MPa CONCRETE WITH SL92 MESH IN WALLS AND BASE.
- 12. CONTRACTOR TO VERIFY EXISTING SERVICES CONNECTION LEVELS PRIOR TO CONSTRUCTION. ANY DISCREPANCIES MUST BE IMMEDIATELY IDENTIFIED AND THE SUPERINTENDENT NOTIFIED PRIOR TO CONSTRUCTION COMMENCING.

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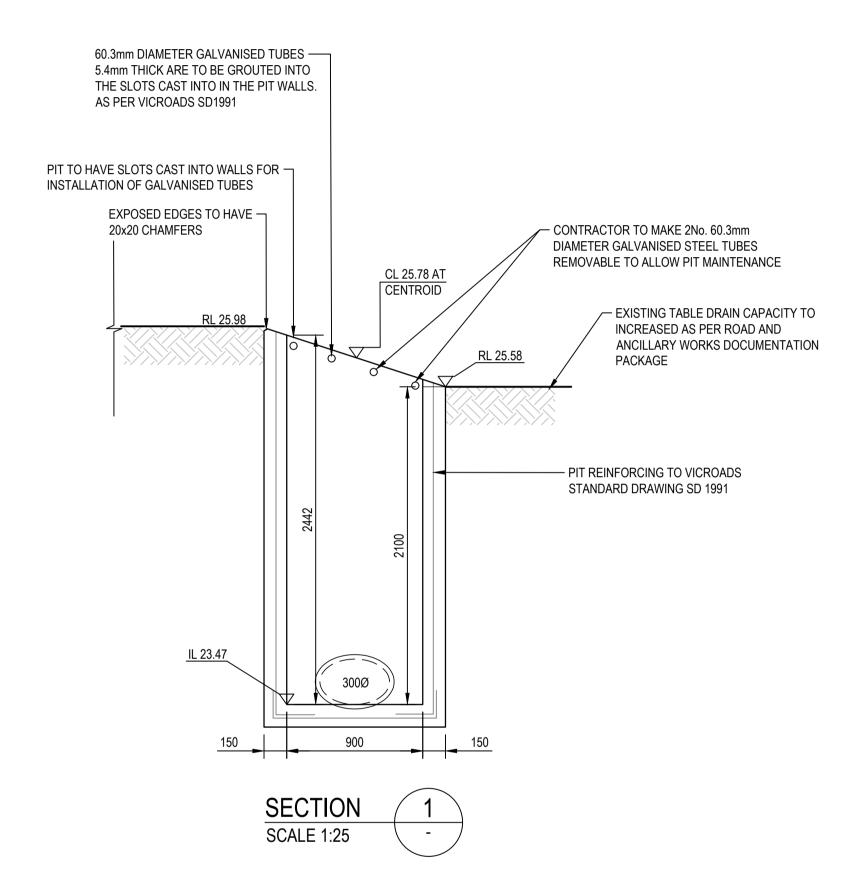
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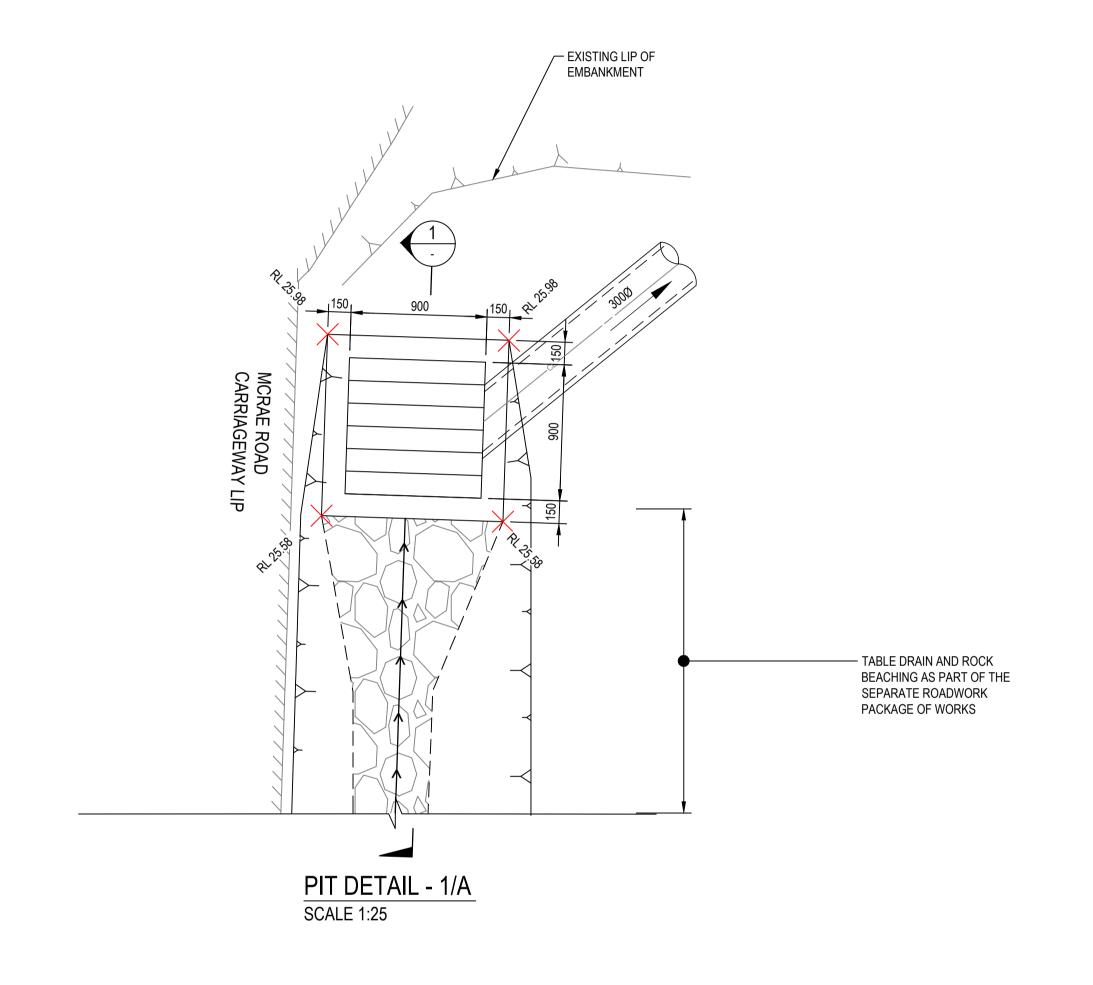
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Client COLAC OTWAY SHIRE

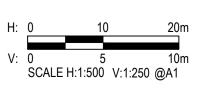Project WYE RIVER AND SEPARATION CREEK STORMWATER
MANAGEMENT SYSTEM
DETAILED DESIGN PITS AND PIPES

Title WYE RIVER SOUTH
DRAINAGE PIT SCHEDULE





WARNING EXTERNAL APPROVAL

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SCALE 1:25

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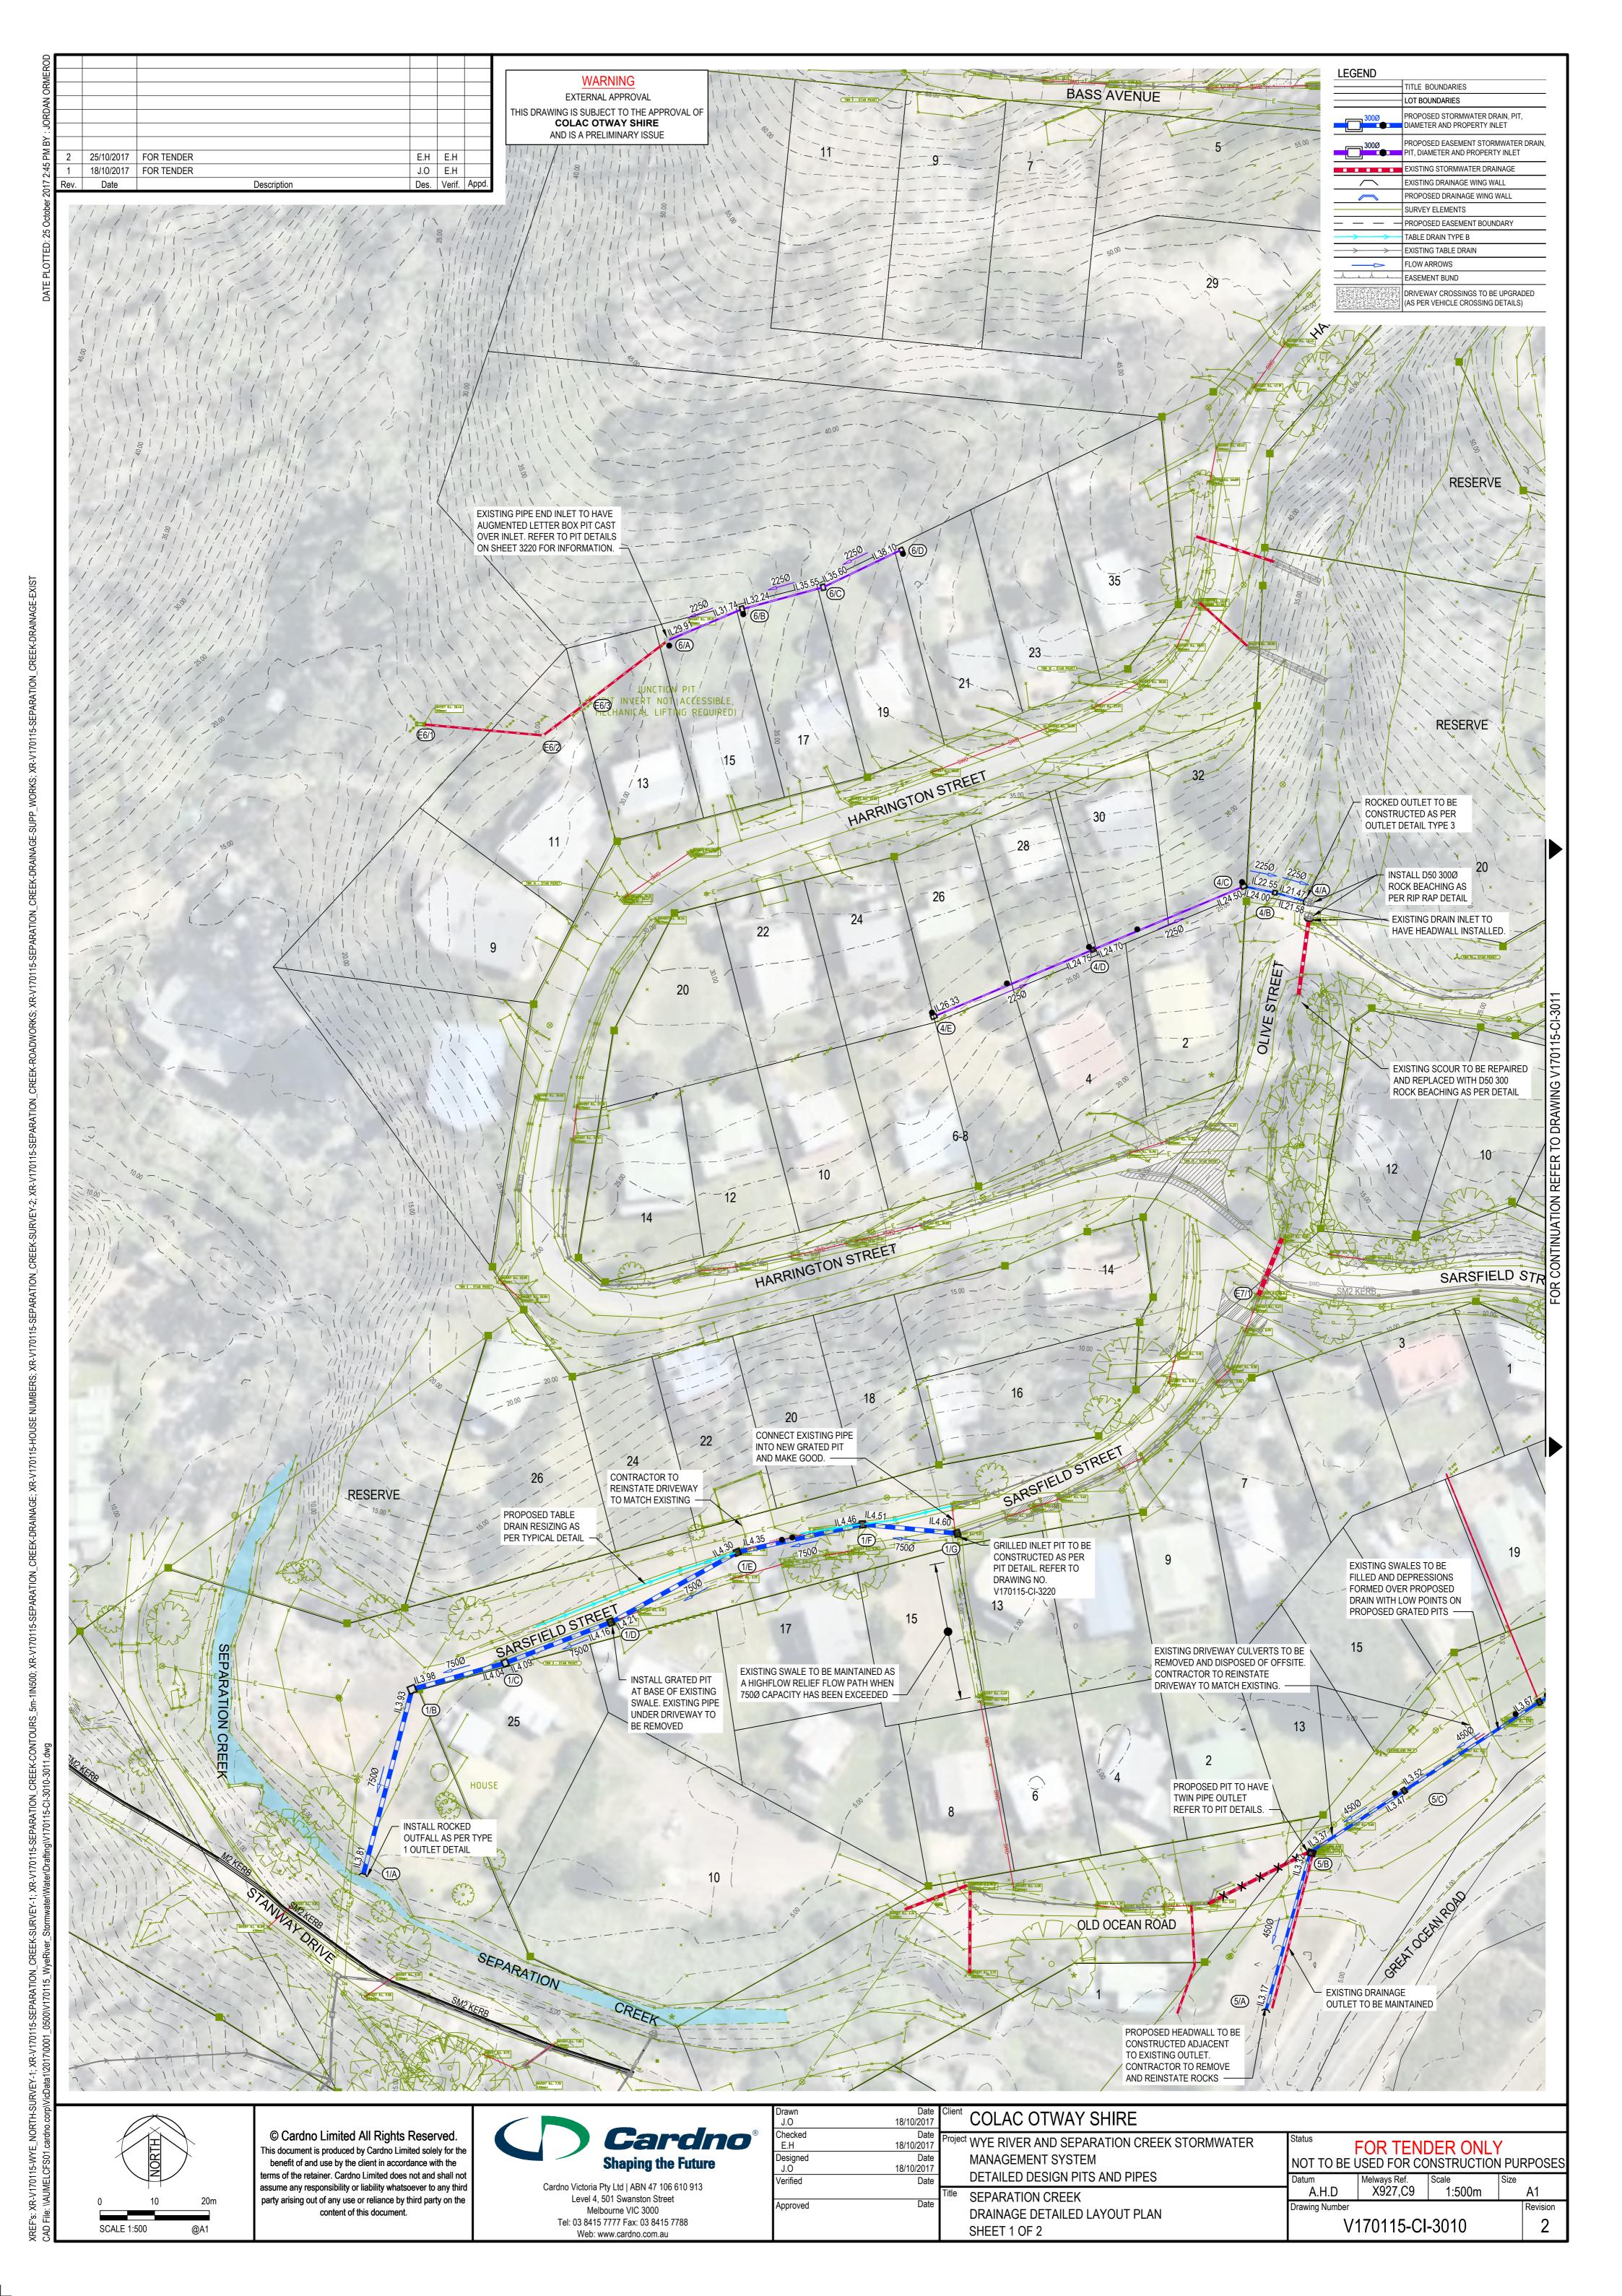
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Date 18/10/2017	Project WYE RIVER AND SEPARATION CREEK STORMWATER
Date 18/10/2017	MANAGEMENT SYSTEM
Date	DETAILED DESIGN PITS AND PIPES
Data	Title WYE RIVER SOUTH
Date	DRAINAGE PIT DETAILS


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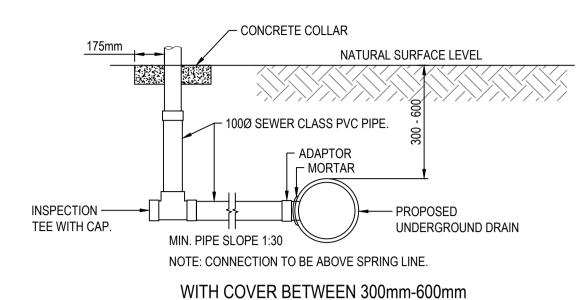
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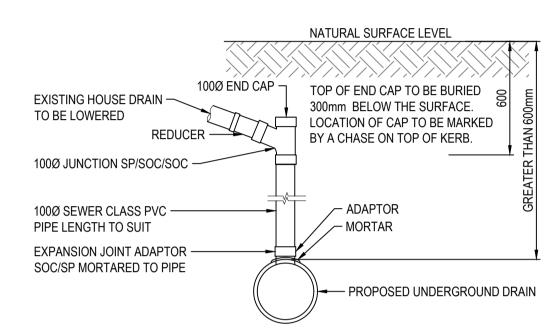
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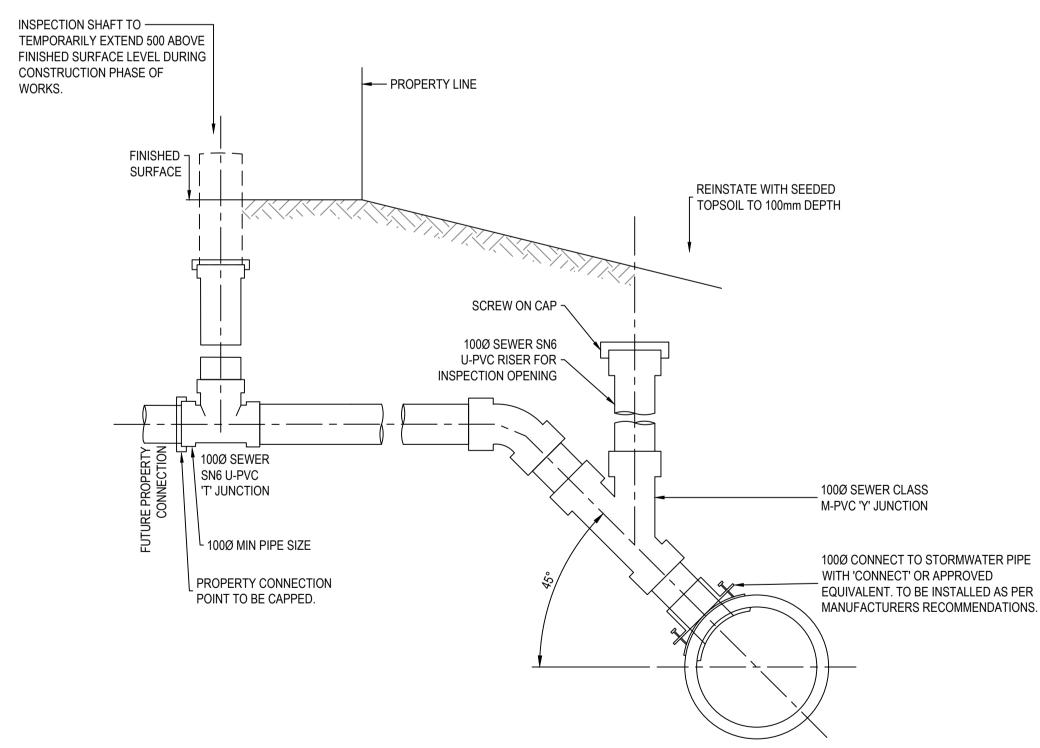







WITH COVER GREATER THAN 600mm


PIPE TO PIPE CONNECTION DETAIL NOT TO SCALE

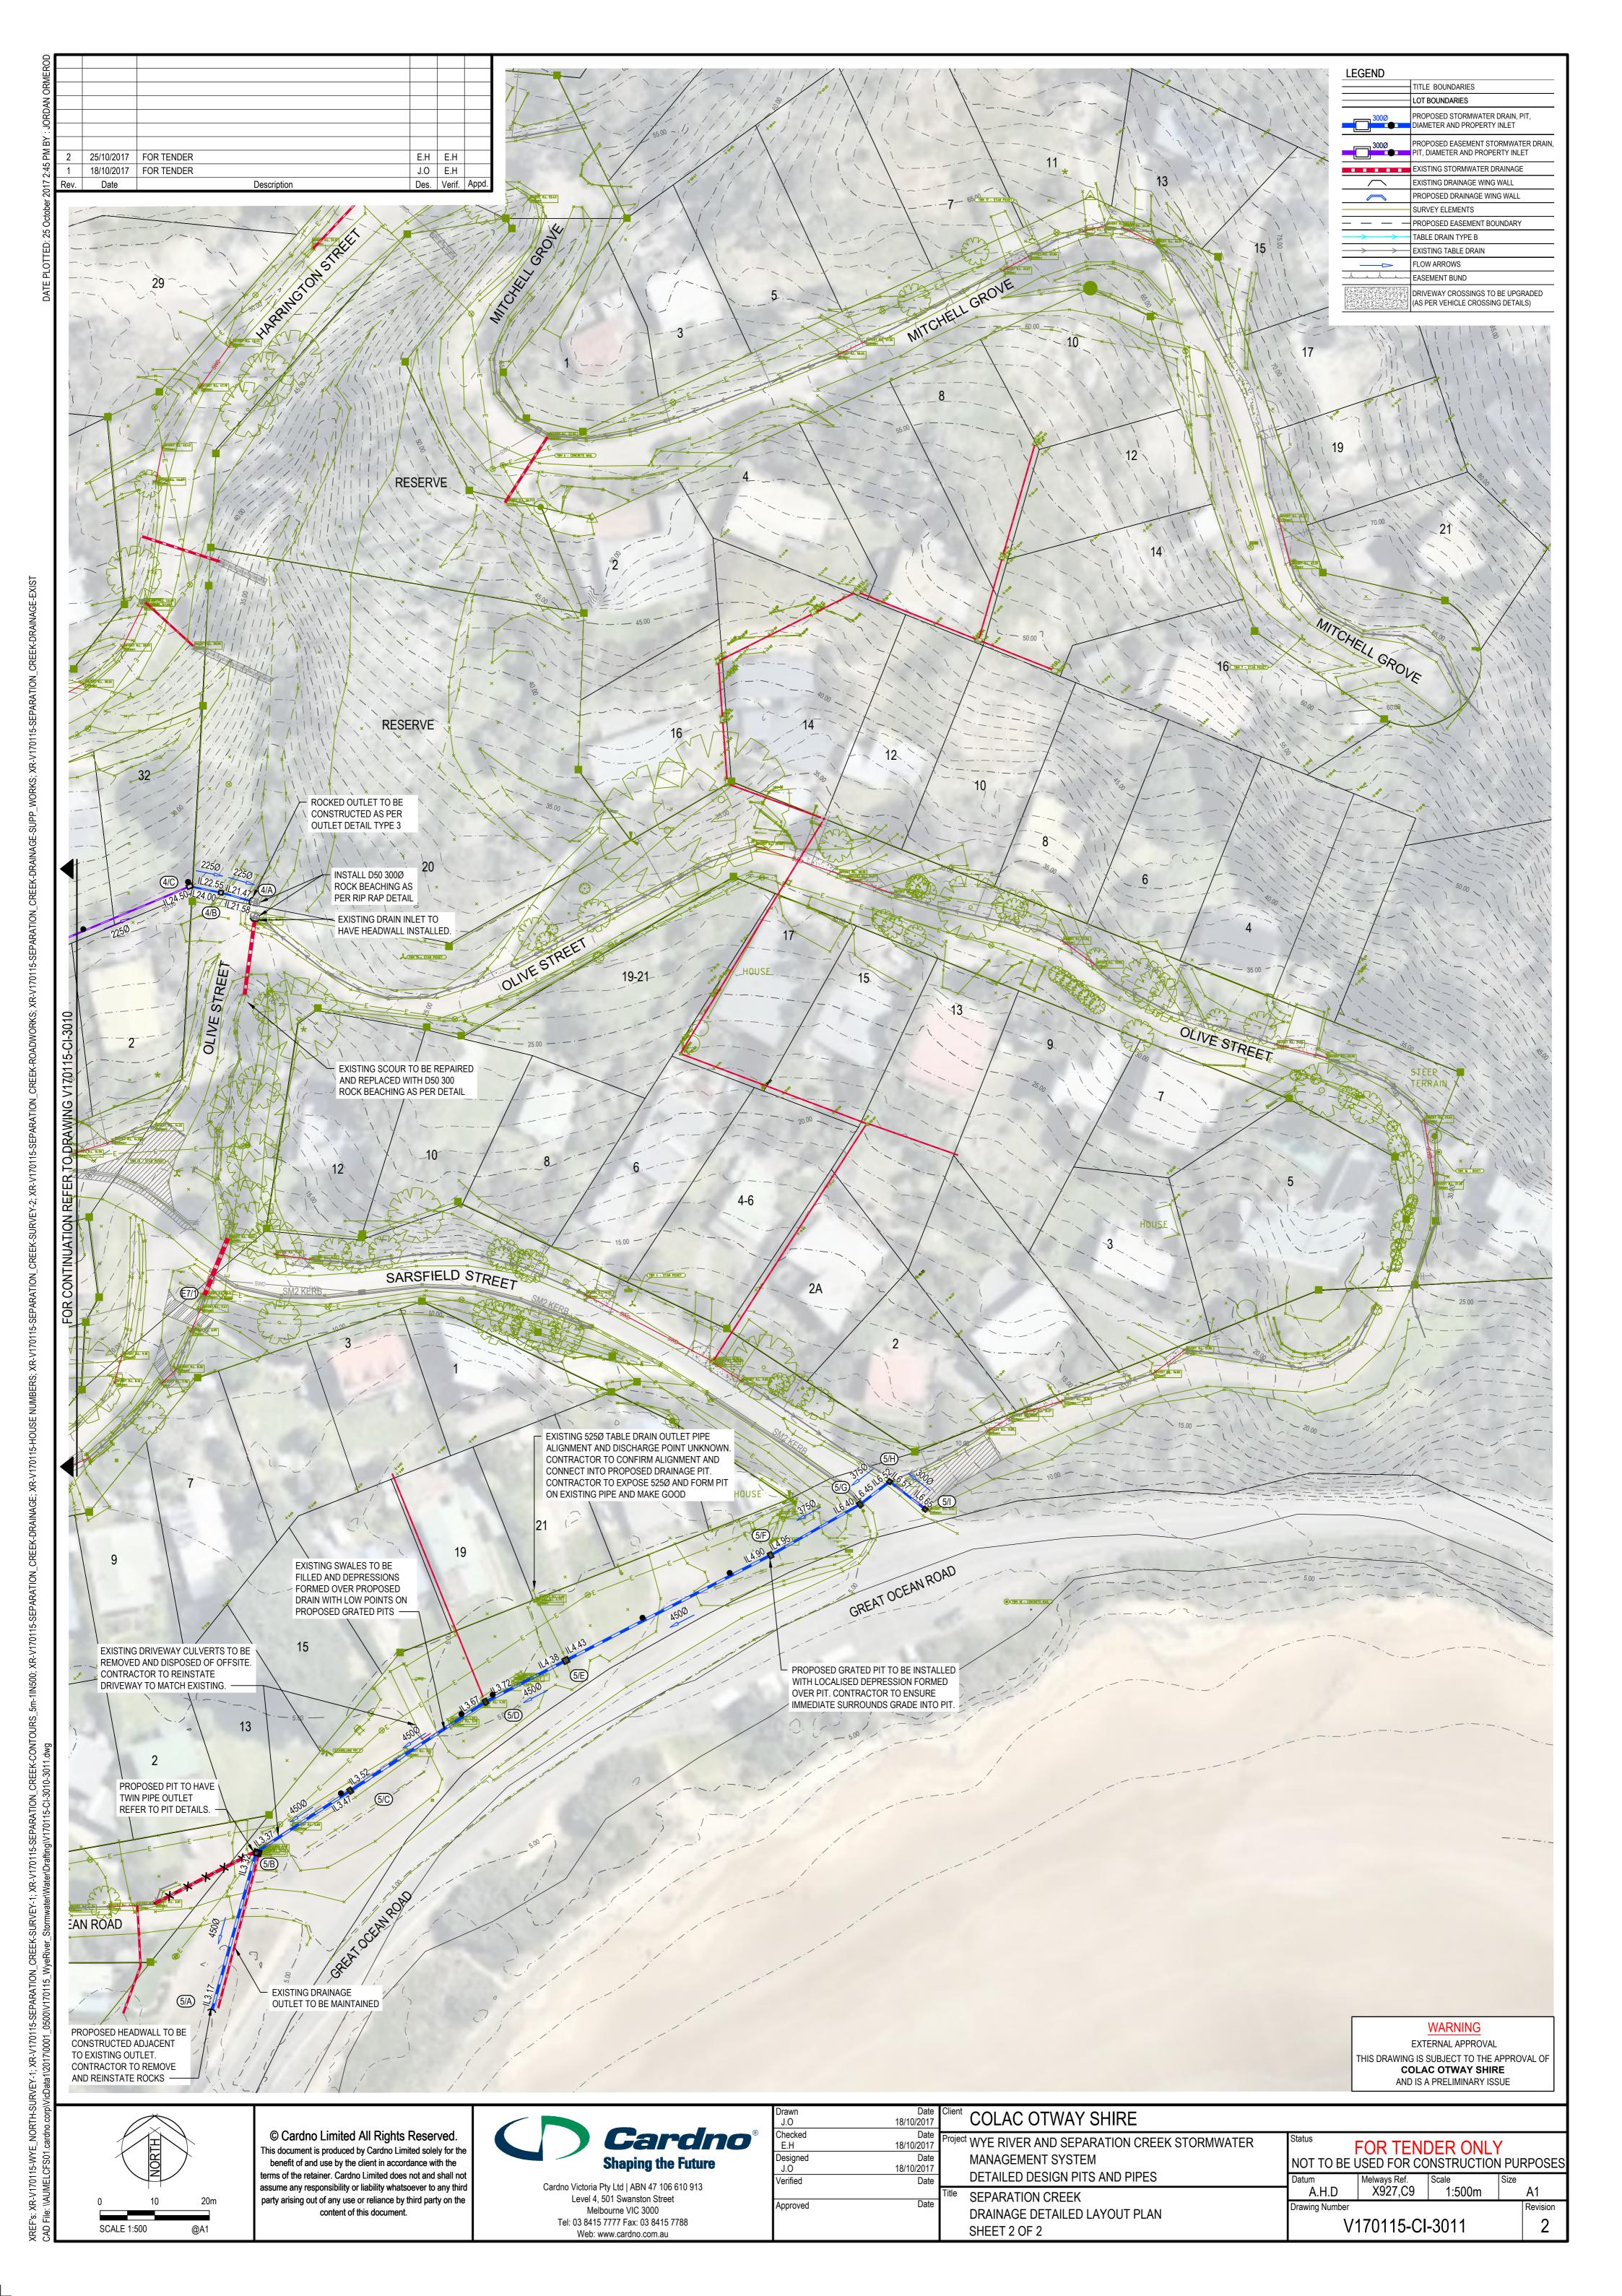

1. REFER TO PLUMBING CODE OF AUSTRALIA FOR ALL PIPE LAYING AND JOINTING REQUIREMENTS. TRUNK DRAIN CONNECTION

(45° TO PIPE WHERE COVER LIMITED OR STEEP GROUND) NOT TO SCALE

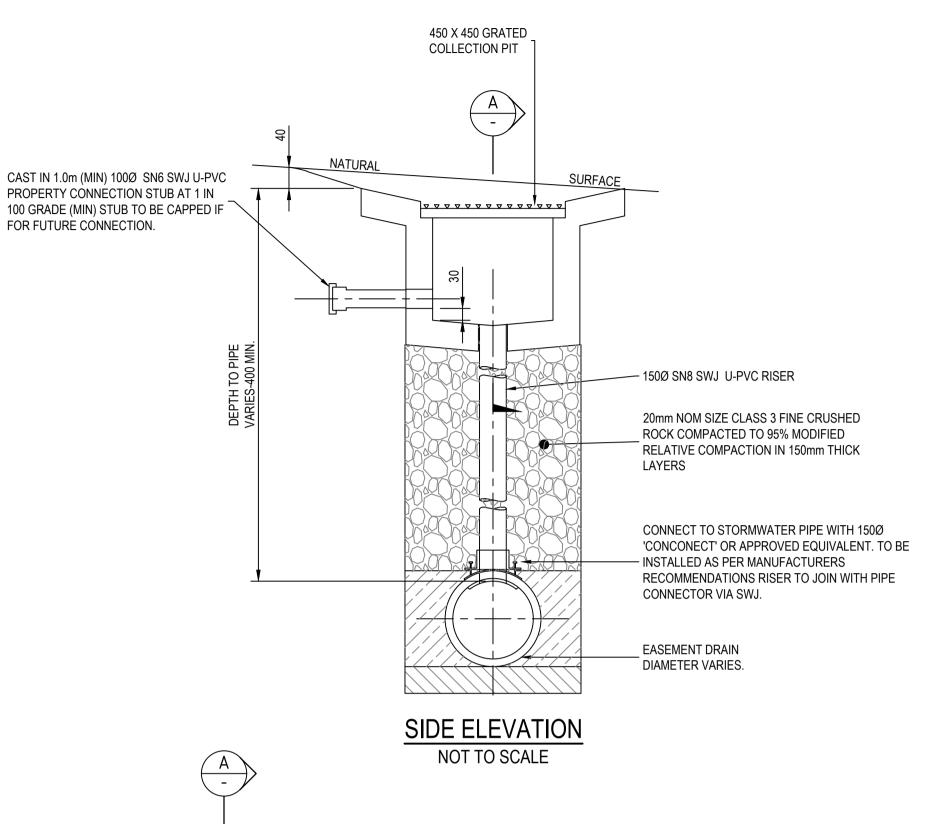

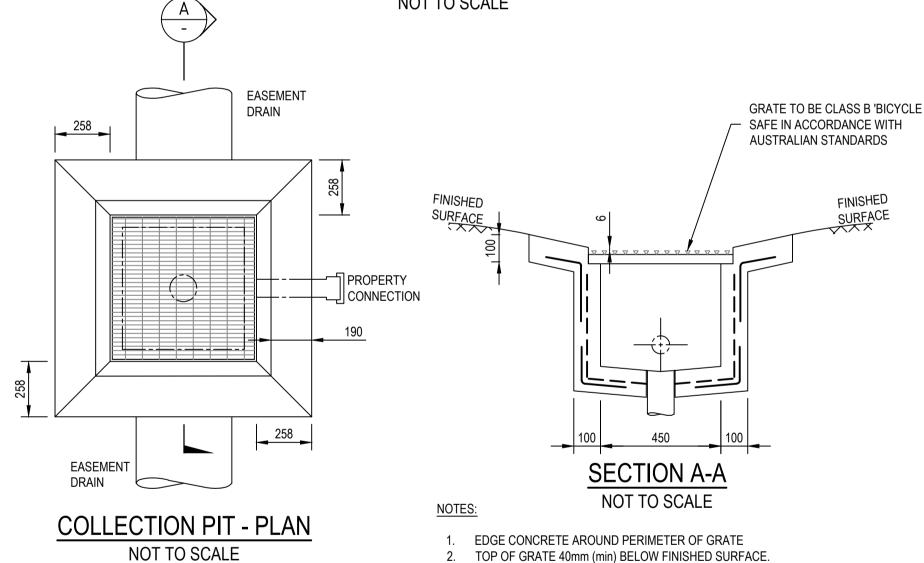

EDGE CONCRETE AROUND PERIMETER OF GRATE

TOP OF GRATE 40mm (min) BELOW FINISHED SURFACE.

DO NOT BOND GRATE TO CONCRETE TO ALLOW EASY ACCESS TO PIT. CONCRETE TO BE SMOOTH TROWELLED FINISH.

GRATE FRAME TO BE OILED IF INSTALLED IN WET CONCRETE.

CONCRETE STRENGTH F'C = 25MPa. (MIN) AT 28 DAYS

SEAL UP AND MAKE GOOD PIPE CONNECTION / INSERTION TO PIT. 8. PROPERTY CONNECTION MIN 100Ø PIPE AS PER CLAUSE 16.10.2 (PIPE DIAMETERS).

EASEMENT DRAIN CONNECTION - PITS

NOT TO SCALE

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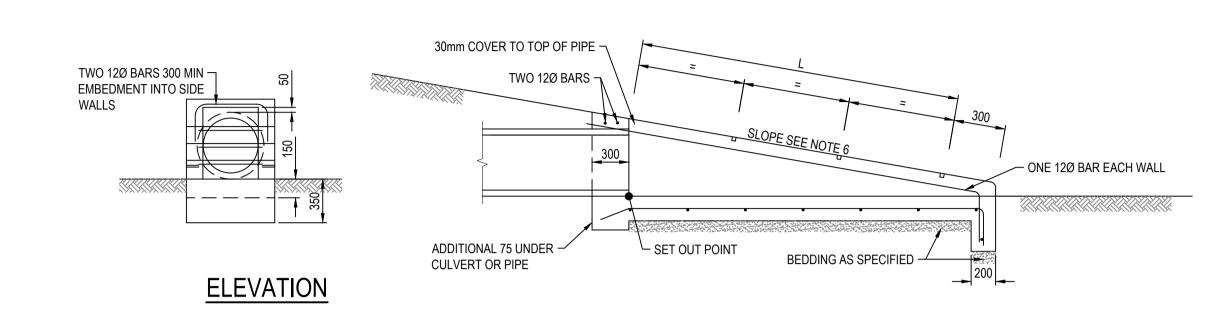
COLAC OTWAY SHIRE Diect WYE RIVER AND SEPARATION CREEK STORMWATER MANAGEMENT SYSTEM DETAILED DESIGN PITS AND PIPES SEPARATION CREEK

DRAINAGE TYPICALS

SHEET 1 OF 4

FOR TENDER ONLY NOT TO BE USED FOR CONSTRUCTION PURPOSES

X927,C9 AS SHOWN A1 V170115-CI-3100




- REINFORCEMENT, SL81 UNLESS OTHERWISE SPECIFIED, SHALL BE CONTINUOUS AROUND CORNERS AND LOCATED AS SHOWN.
- CLEAR COVER 50 MIN. LAPS, FABRICS 300 MIN., BARS 25XBAR DIAMETER MIN.
- 3. CONCRETE STRENGTH N32 AT 28 DAYS EXPOSED EDGES SHALL HAVE 20x20 CHAMFERS
- RAILS WITHIN SECTION "L" SHALL BE EVENLY SPACED. THE MAXIMUM SPACING SHALL NOT EXCEED 600mm.
- 6. RAILS ARE 60.3mm DIAMETER GALVANIZED TUBES 5.4mm THICK. THESE ARE TO BE GROUTED INTO THE SLOTS IN THE WALLS.


SLOPE OF ENDWALL TO MATCH BATTER SLOPE MAXIMUM SLOPE 4 TO 1.

'L' (mm)	TOTAL NUMBER OF RAILS
100-600	1
601-1200	2
1201-1800	3
1801-2400	4

DRIVEABLE ENDWALL TYPE 1 NOT TO SCALE

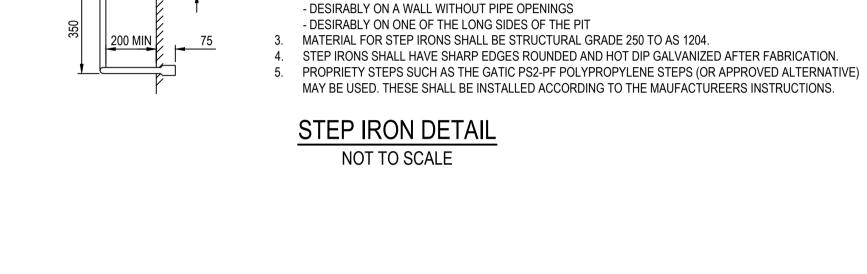

PLAN

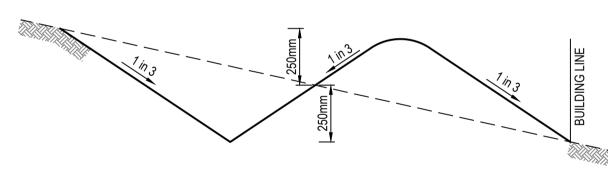

1. PITS DEEPER THAN 1000mm SHALL BE FITTED WITH STEP IRONS.

- DIRECTLY BELOW THE OPENING IN THE COVER


2. STEP IRONS SHALL BE LOCATED:

UNDERSIDE OF COVER -

OPEN CATCH DRAIN DETAIL

NOT TO SCALE

NOTE: CATCH DRAINS TO BE GRADED TO NOMINATED OUTLETS. FINISH WITH 100mm TOPSOIL

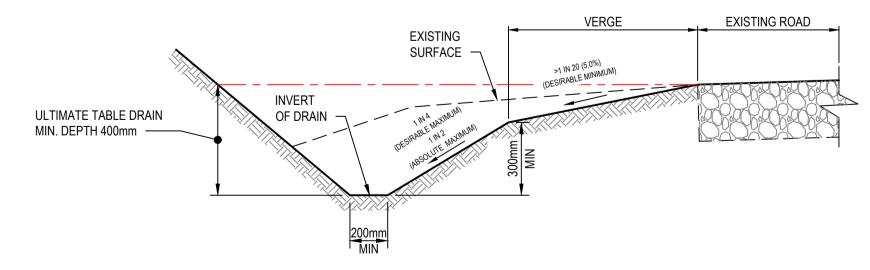

TYPICAL TABLE DRAIN (TYPE-B) NOT TO SCALE

WARNING EXTERNAL APPROVAL

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RAILS, SEE NOTE 6 —

PLAN

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Client	COLAC OTWAY SHIRE
Project	WYE RIVER AND SEPARATION CREEK STORMWATER
	MANAGEMENT SYSTEM
	DETAILED DESIGN PITS AND PIPES
Title	

PARATION CREEK STORIVIWATER	Status NOT TO BE U	FOR TENI		•
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	MANAGEMENT SYSTEM	NOT TO BE	USED FOR CO	ONSTRUCTION	N PU	RPOS
	DETAILED DESIGN PITS AND PIPES	Datum	Melways Ref.	Scale	Size	
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- 1. BULKHEADS ARE REQUIRED FOR PIPES 300mm DIAMETER OR
- 2. BULKHEAD TO BE LOCATED DIRECTLY BEHIND DOWNSTREAM OF
- COLLAR SO AS NOT TO ENCASE THE JOINT 3. LOCATE BULKHEAD AT A RETAINING WALL UNDER THE WALL.
- 4. KEY CONCRETE BULKHEADS INTO SIDES AND BOTTOM OF TRENCH
- AGAINST A BEARING SURFACE OF UNDISTURBED SOIL CONCRETE TO BE CLASS N25
- DO NOT DEFORM PIPES DURING PLACEMENT OF CONCRETE
- PROVIDE CONTINUOUS DRAINAGE PATH THROUGH BULKHEADS 8. COMPRESSIBLE MEMBRANE AROUND PIPE TO BE 3 THICK RUBBER FOR
- BULKHEADS ON SLOPES

- PIPE BEDDING AND BACKFILL

REQUIREMENTS. REFER TO

SUBJECT TO TRENCHING

PIPE TRENCH DETAILS


COMPRESSIBLE MEMBRANE AROUND PIPES. (SEE NOTE 6)


15% > PIPE GRADE > 50% .

NOT TO SCALE


- 9. GROUNDWATER DRAIN THROUGH BULKHEAD IS NOT REQUIRED WHEREVER BACKFILL IS CEMENT TREATED
- 10. GROUNDWATER DRAINS THROUGH BULKHEADS SHALL BE FILLED WITH
- FIBREGLASS WOOL OR OTHER APPROVED FILTER MATERIAL 11. BULKHEADS SHALL BE CONSTRUCTED AT EVERY SECOND JOINT WHERE PIPE GRADES EXCEED 15% (1 in 6.7) AND CEMENT TREATED

BACKFILL IS NOT SPECIFIED. REFER TYPICAL DETAIL

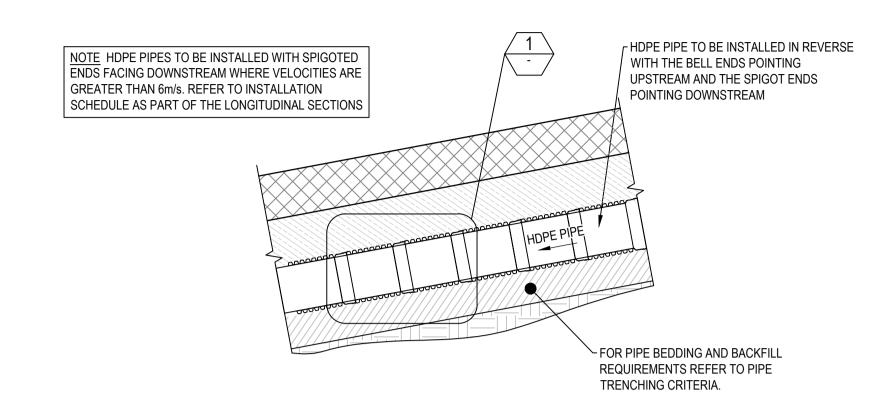


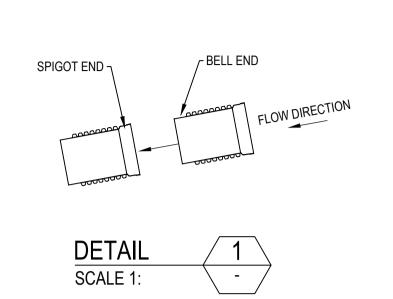



HIGH VELOCITY HDPE PIPE INSTALLATION DETAIL NOT TO SCALE

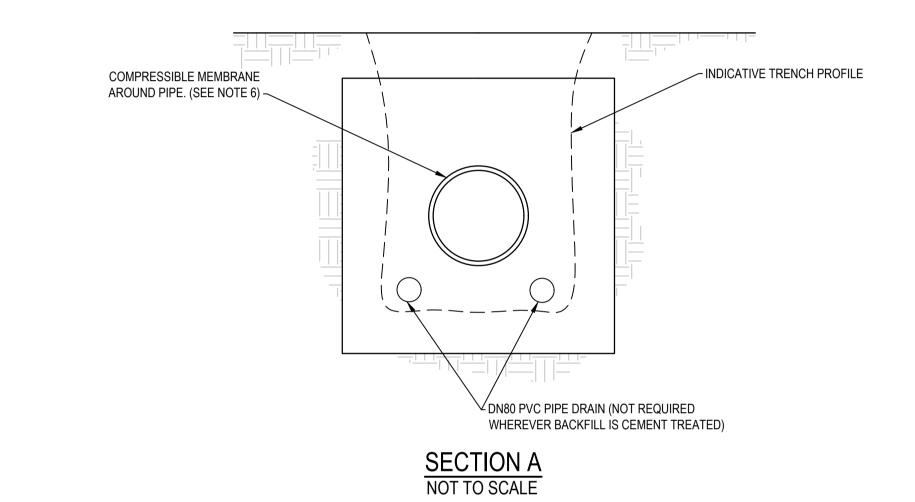

PLANT SCHEDULE FOR SLOPES STEEPER THAN 1 IN 2								
BOTANICAL NAME	COMMON NAME	PLANT DENSITY	NOTES					
GOODENIA OVATA	HOP GOODENIA	1 -2 PLANTS PER 50m2	DISPERSED PLANTING AND PLANT AT TOP OF BANKS/TRANSITION BETWEEN ROAD AND PIPE TRENCH					
CORREA ALBA	WHITE CORREA	1 -2 PLANTS PER 50m2	DISPERSED PLANTING AND IMMEDIATELY UPSTREAM OF PITS					
POA POAFORMIS	COAST TUSSOCK-GRASS	5 PLANTS PER 5m2	PLANT IN CLUMPS OF 5					
LOMANDRA LONGFOLIA	MAT RUSH	1 -2 PLANTS PER 50m2	DISPERSED PLANTING					
ENCHYLAENA TOMENTOSA	RUBY SALTBUSH	1 -2 PLANTS PER 50m2	DISPERSED PLANTING					
MICROLAENA STIPOIDES	WEEPING GRASS	10g/m2	BEGIN WITH A WEED FREE SEED BED. SOW SEED 10-15mm BELOW THE SOIL SURFACE					

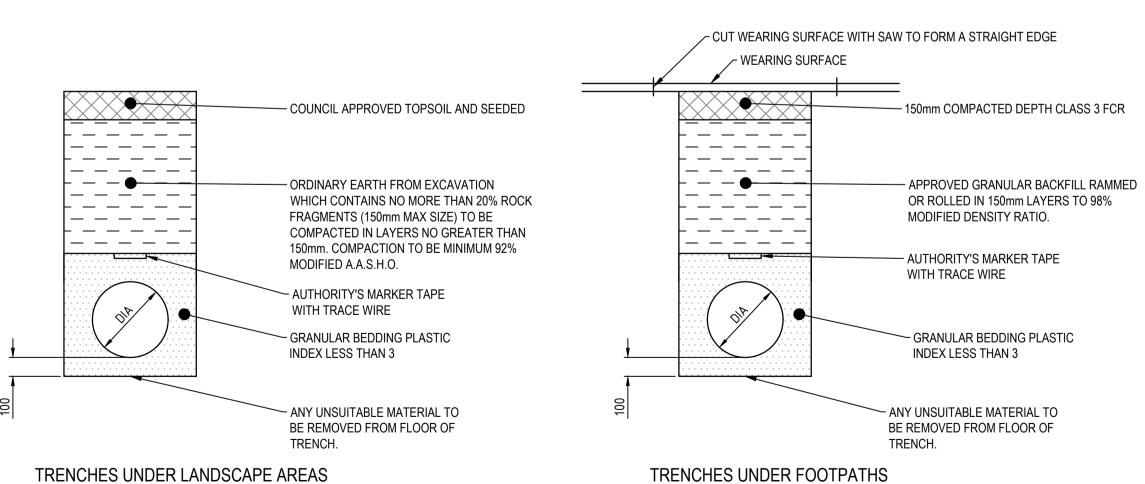

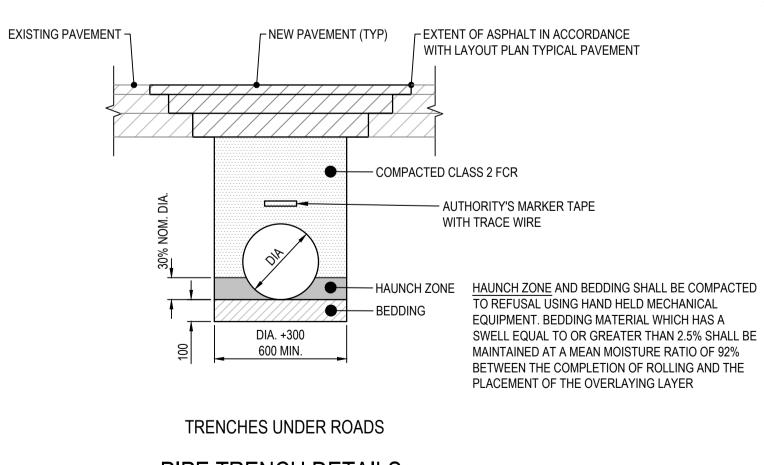

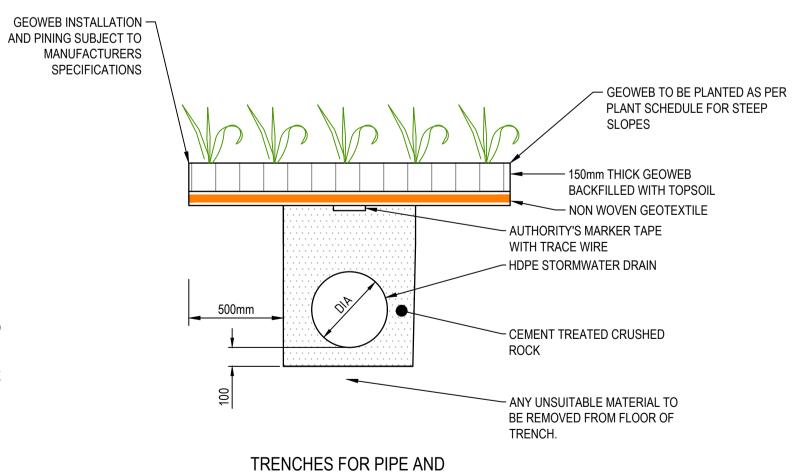

	PIPE TRENCH DETAILS
•	NOT TO SCALE

EMBANKMENT SLOPES STEEPER THAN 1 IN 2 WARNING EXTERNAL APPROVAL THIS DRAWING IS SUBJECT TO THE APPROVAL OF COLAC OTWAY SHIRE AND IS A PRELIMINARY ISSUE

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kREFS: AK-VI/OIIS-DKAINAGE_ 3AD File: \\AUMELCFS01.cardno.α	1	18/10/2017	FOR TENDER	J.O	E.H	
Ä	Rev.	Date	Description	Des.	Verif.	Appd.

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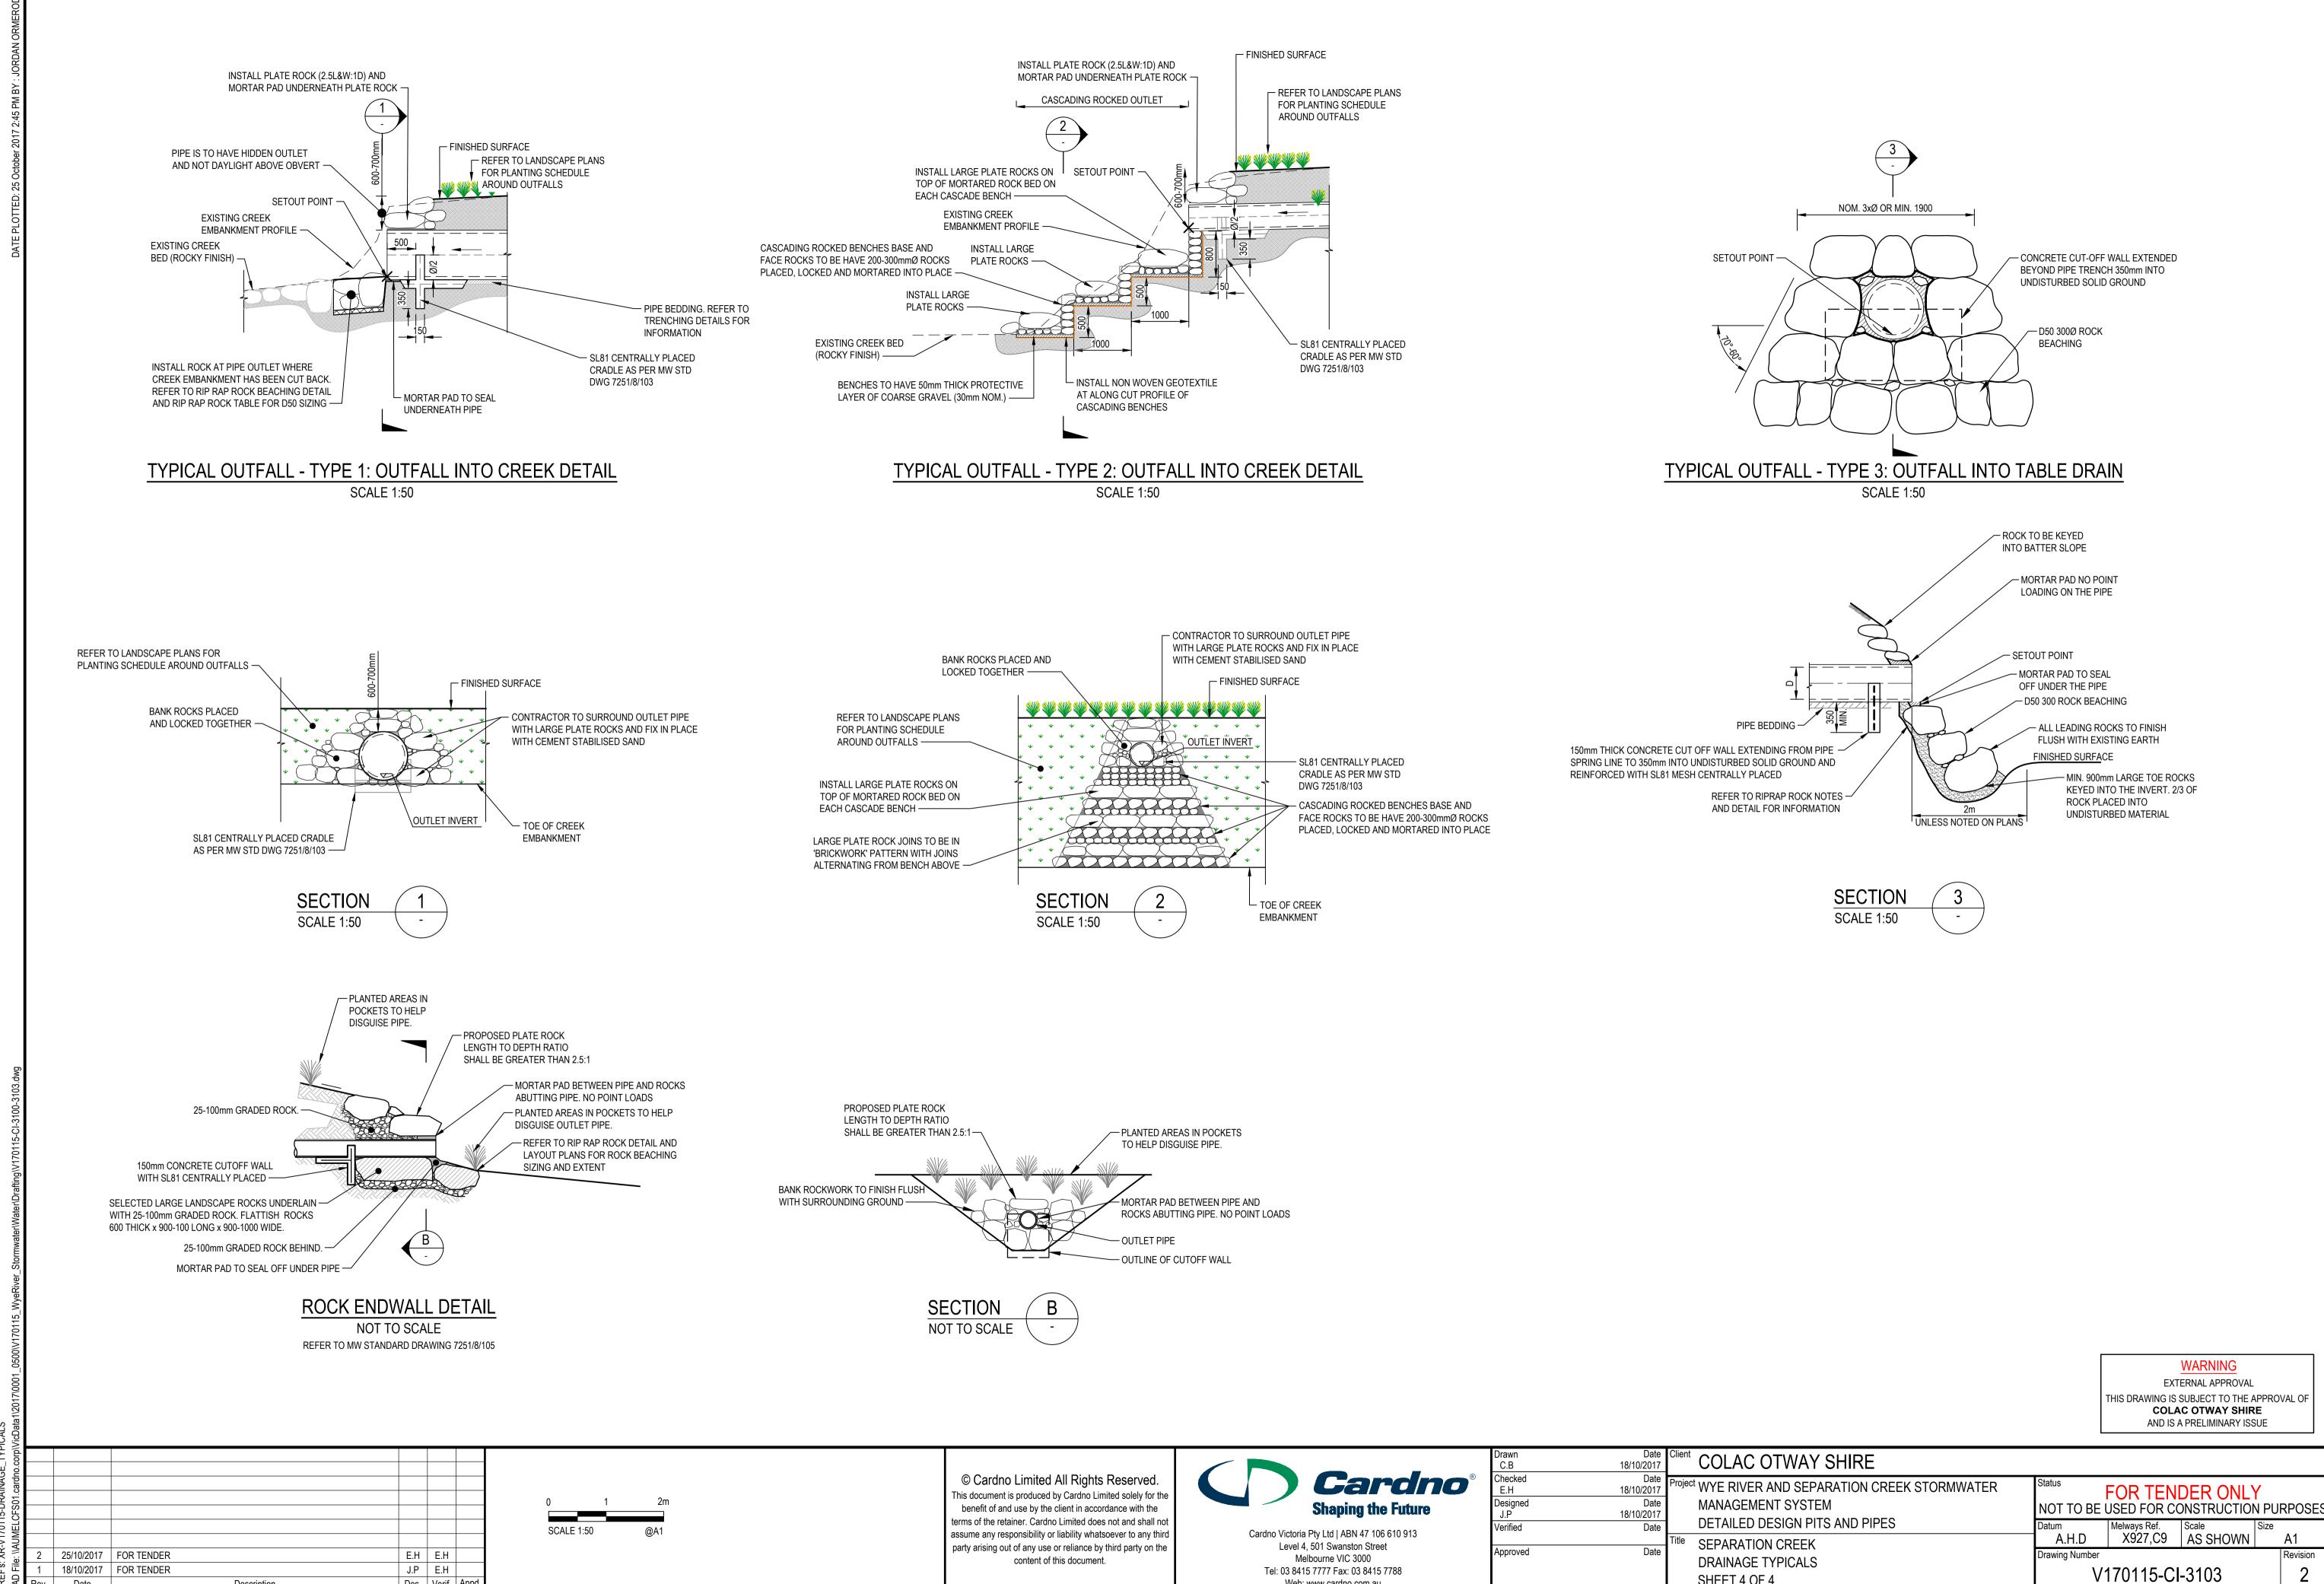


Shaping the Future	Designe J.O
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Level 4, 501 Swanston Street Melbourne VIC 3000	Approve
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Date 18/10/2017	COLAC OTWAY SHIRE
Date 18/10/2017	Project WYE RIVER AND SEPARATION CREEK STORMWATER
Date	MANAGEMENT SYSTEM
18/10/2017 Date	DETAILED DESIGN PITS AND PIPES
D-1-	Title SEPARATION CREEK
Date	DDAINIA OF TV/DIGALO

Status NOT TO BE U		DER ONL' INSTRUCTION	•
Datum	Melways Ref.	Scale	Size
A.H.D	X927,C9	AS SHOWN	A1

		NOT TO BE USED FOR CONSTRUCTION PURPO					
	DETAILED DESIGN PITS AND PIPES	Datum	Melways Ref.	Scale	Size		
Title	SEPARATION CREEK	A.H.D	X927,C9	AS SHOWN		A1	
	DRAINAGE TYPICALS	Drawing Number				Revisio	
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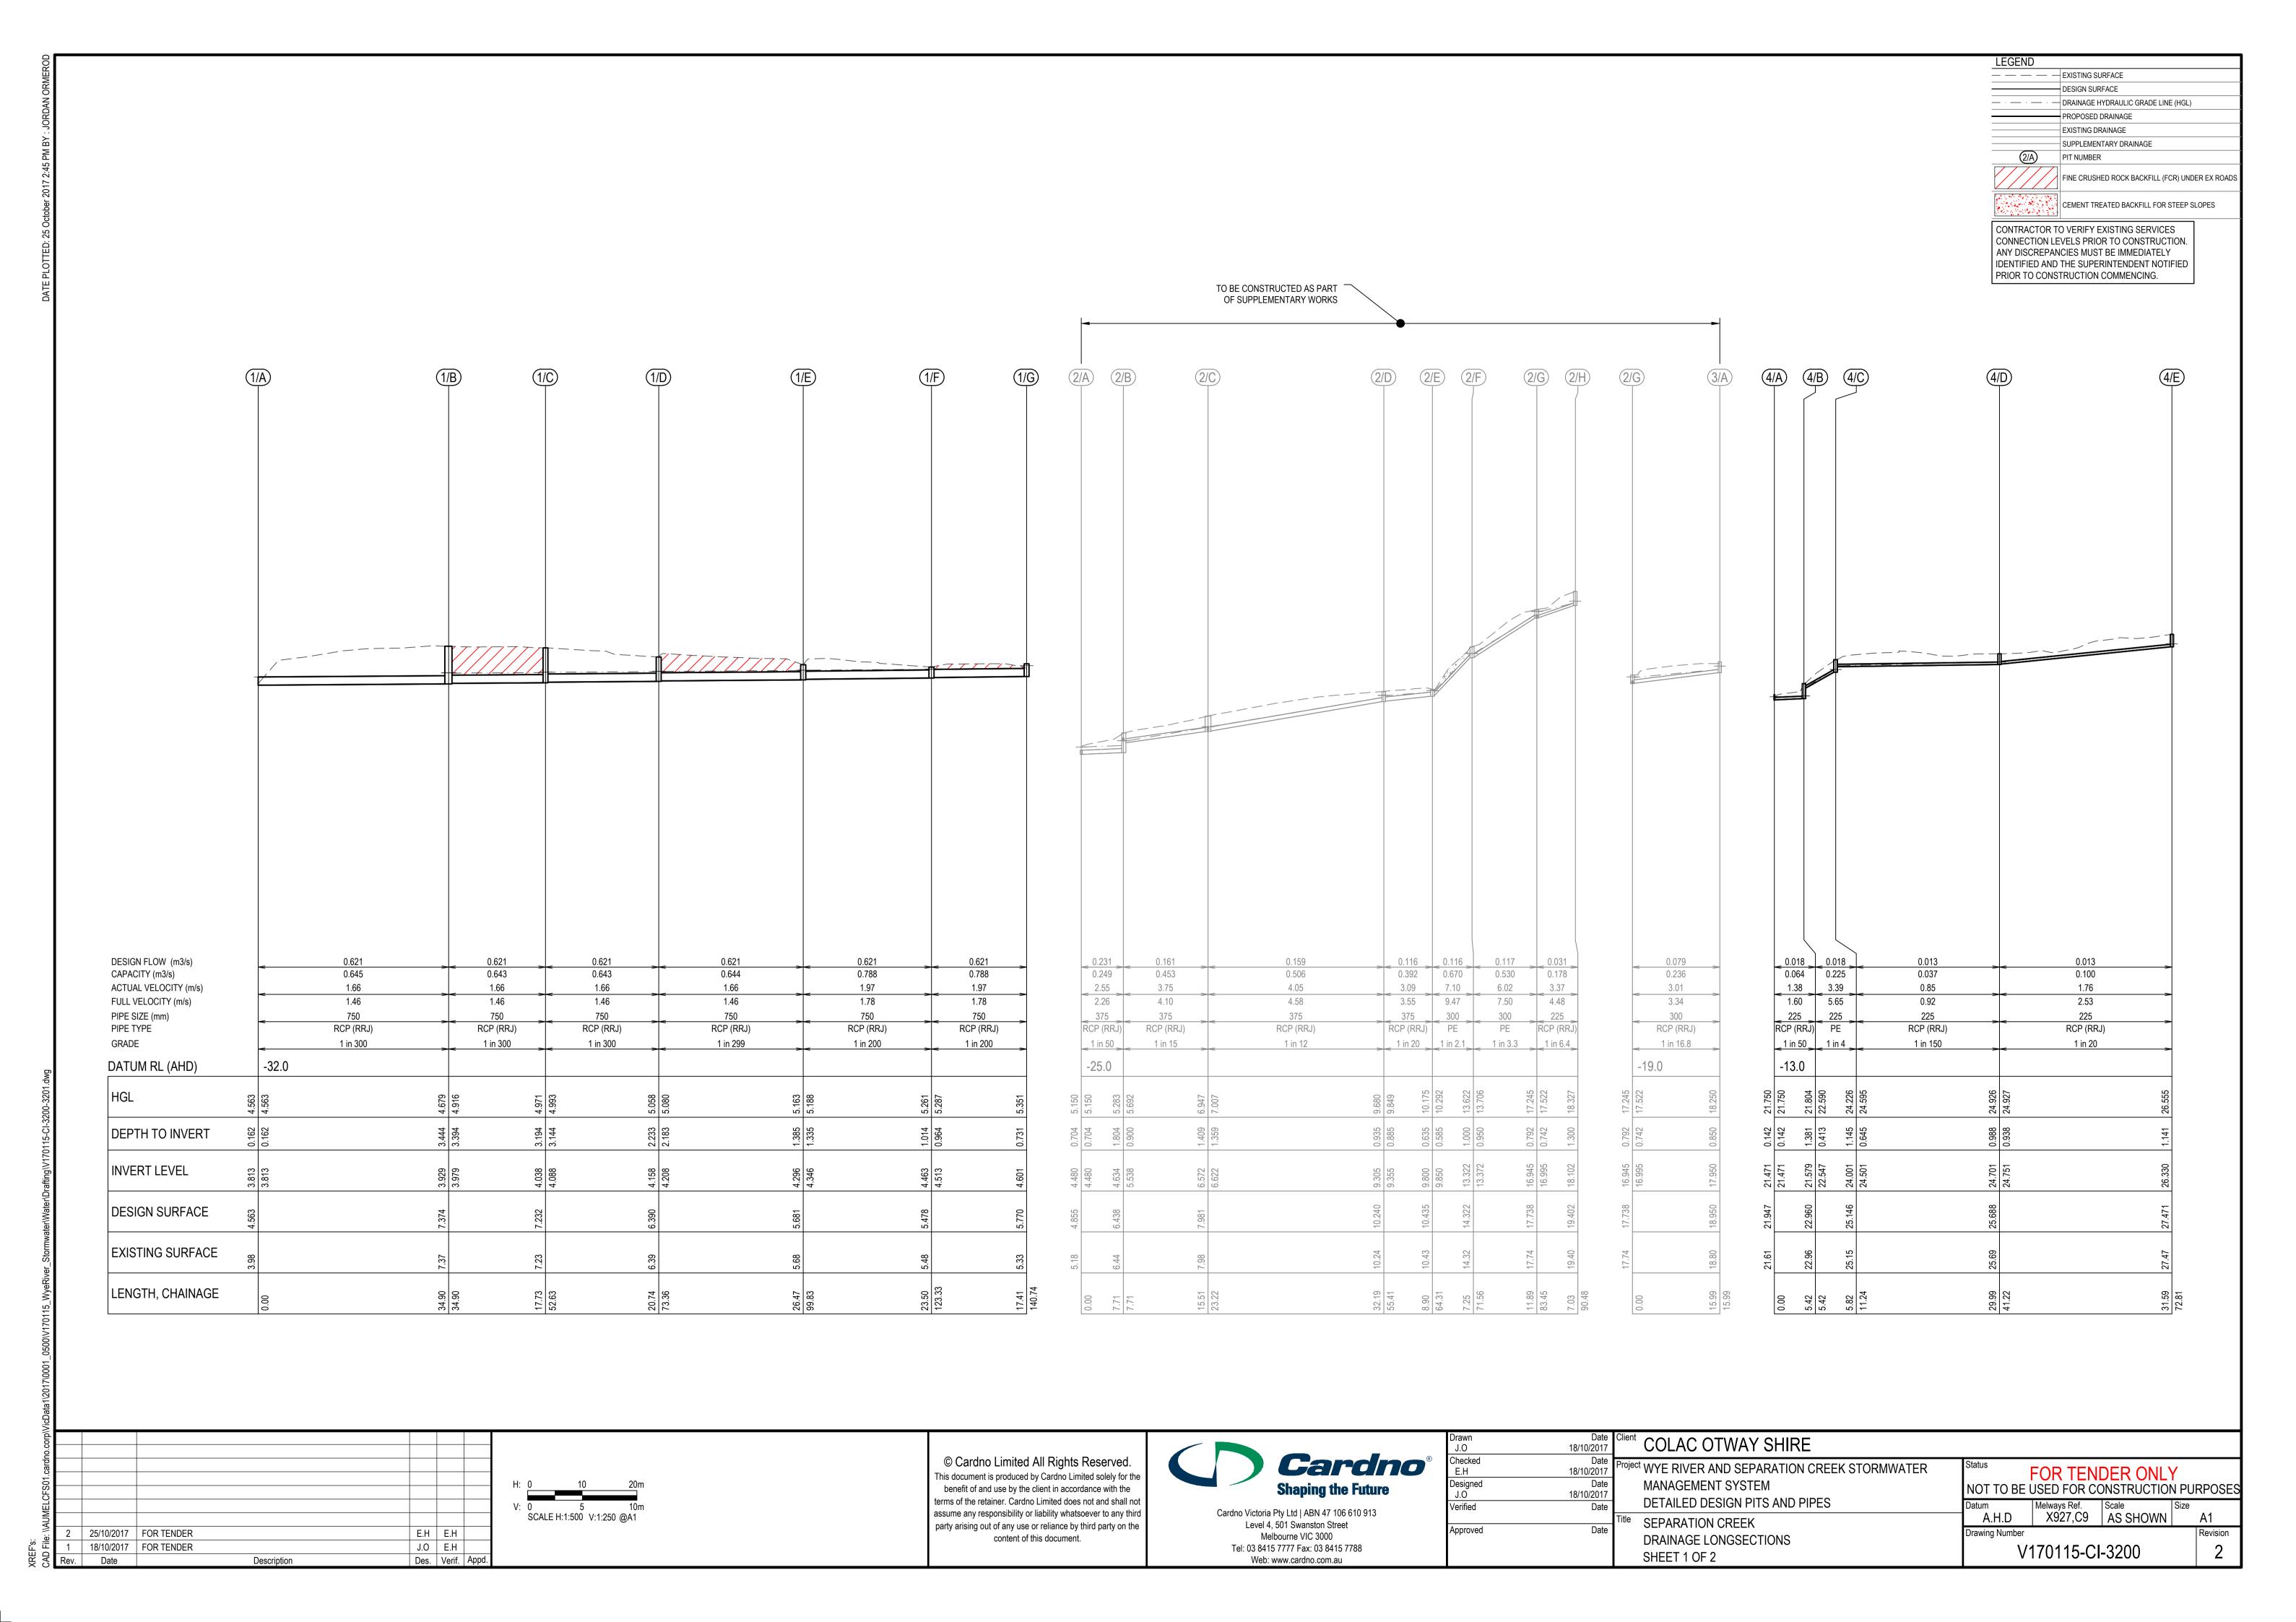
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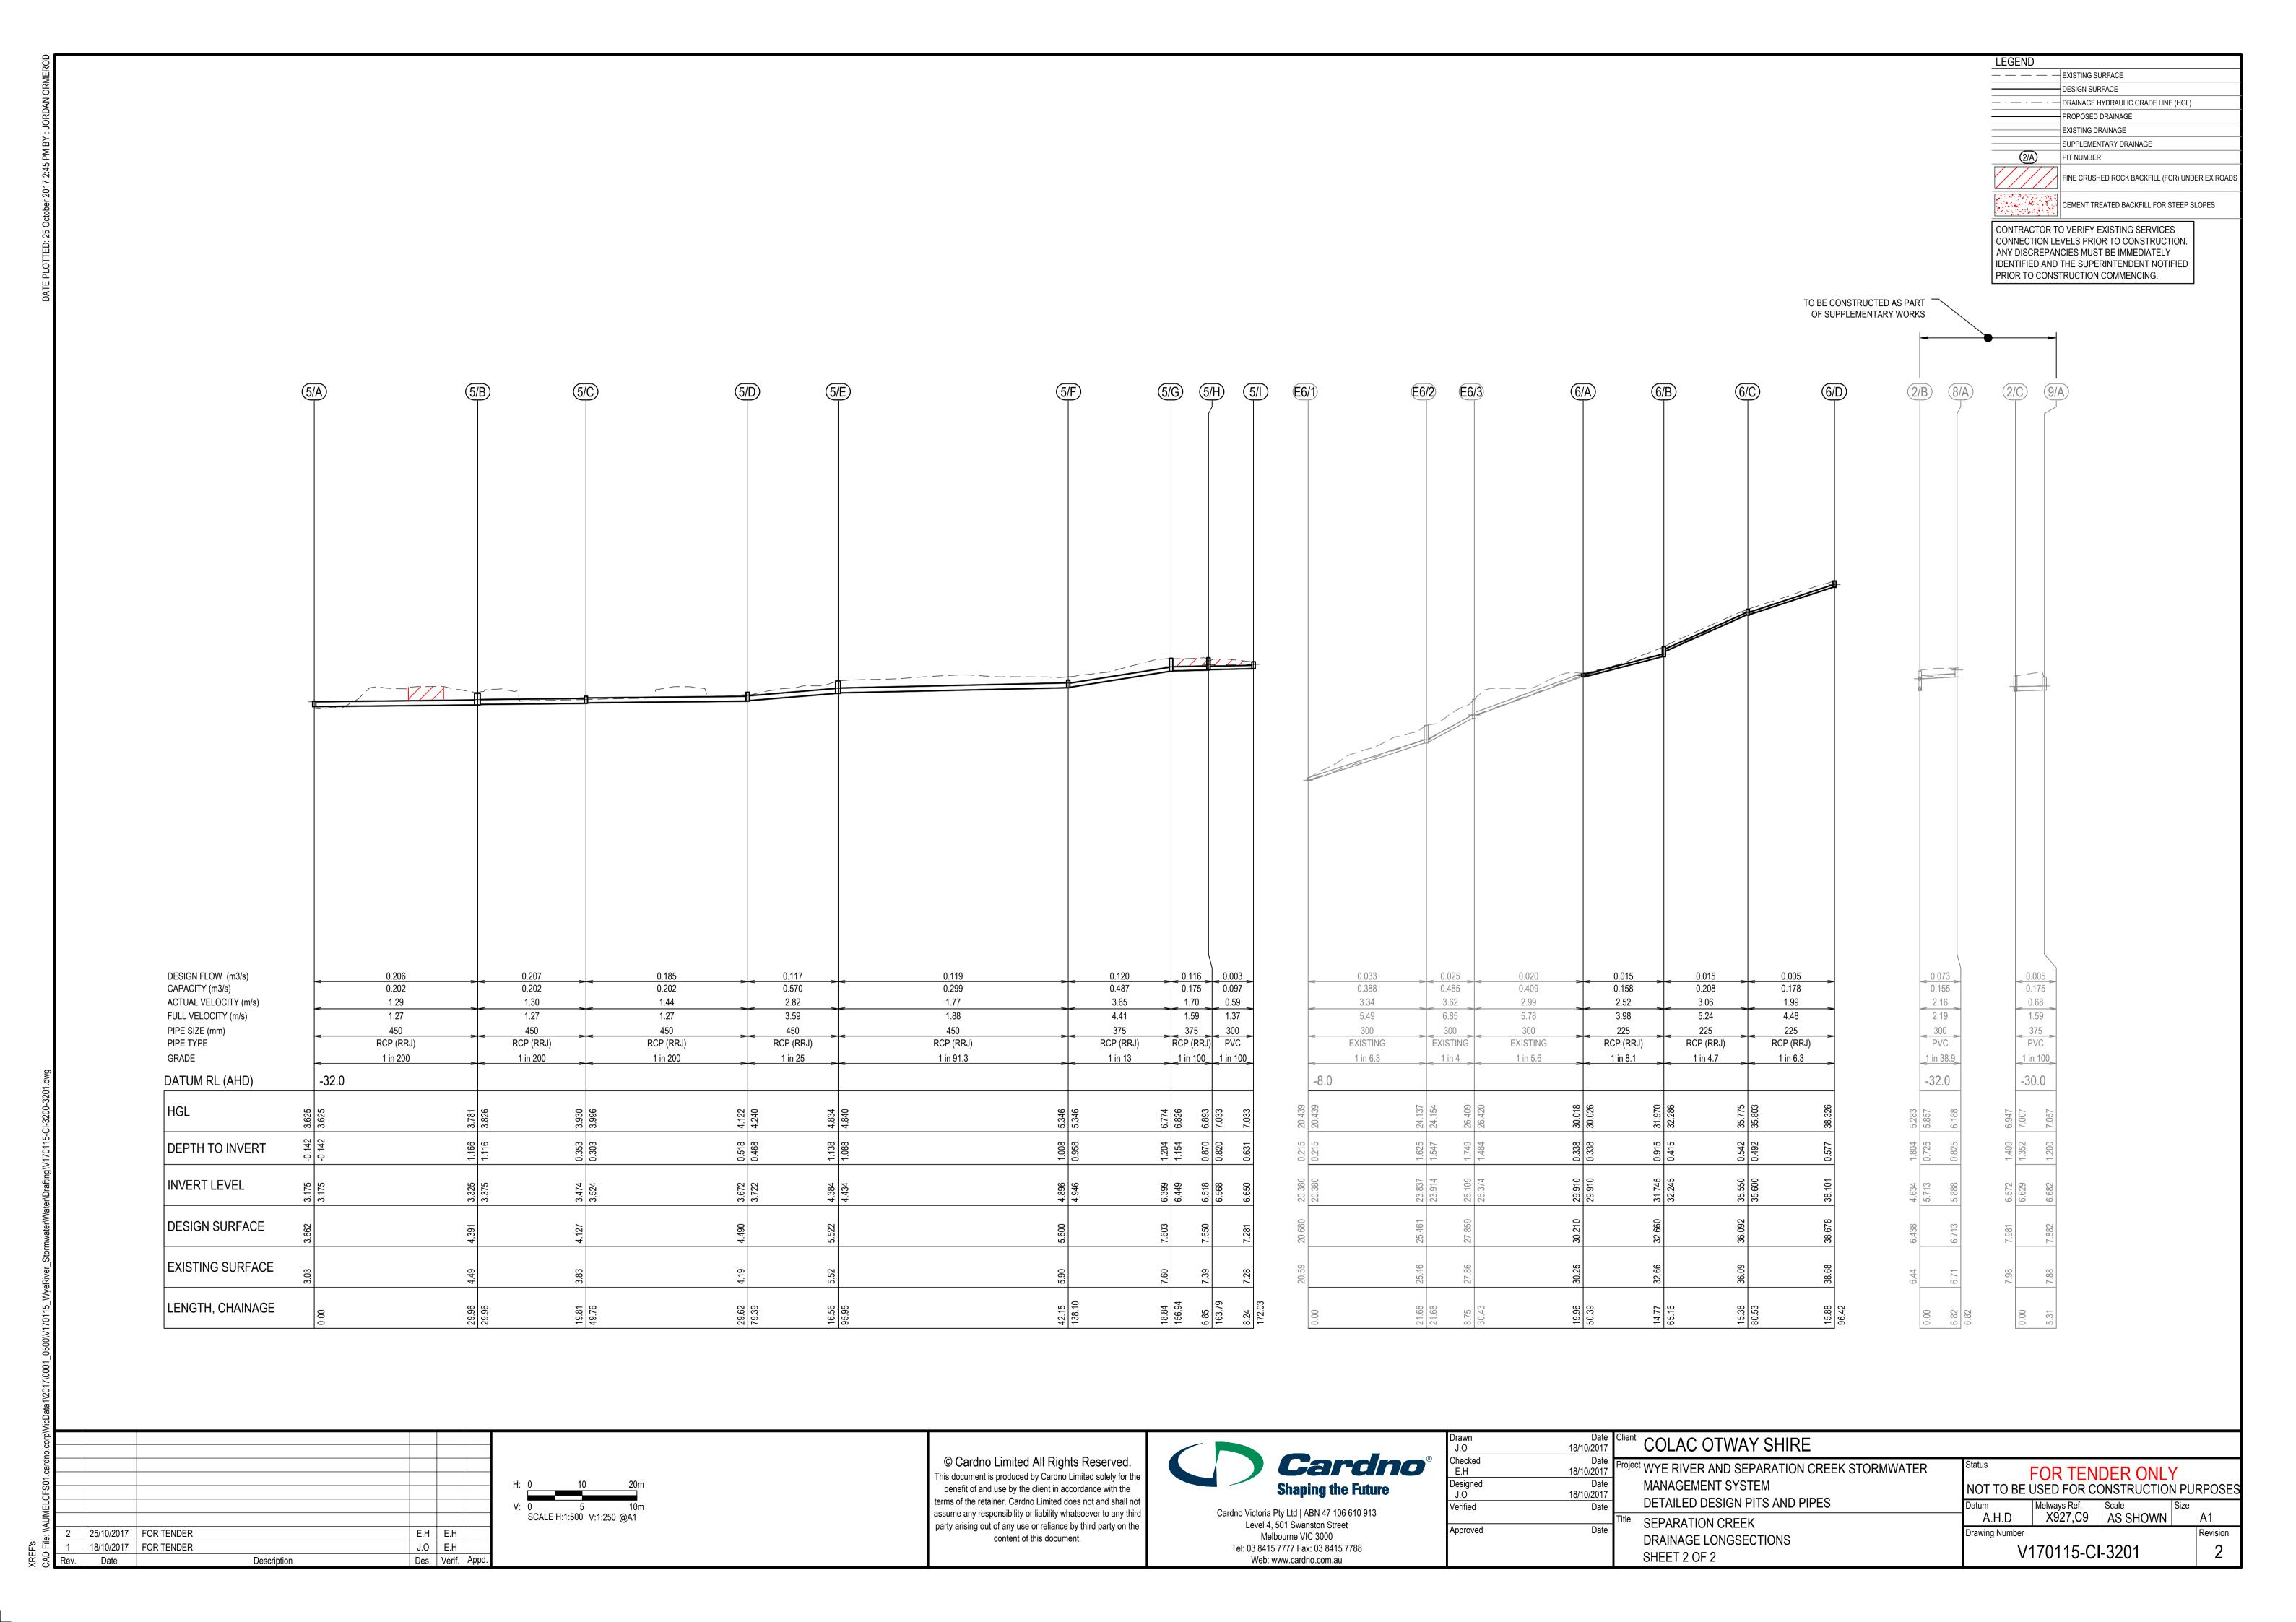
SHEET 4 OF 4

Date

Description

Des. Verif. Appd.






								PIT SCH	HEDUL	E			
	LOCATION			INTERNAL		PIT COVER	CLASS (AS		INLET		OUTLET		
PIT NO	EASTING	NORTHING	TYPE	WD	LEN	LEVEL 3996)	DEPTH	DIA	INV LEV	DIA	INV LEV	COMMENTS	
1/A	752118.263	5720309.151	EW	0	0	4.563		0.75	750	3.813			REINFORCED CONCRETE WINGWAL. REFER TO IDM SD 465.
1/B	752127.141	5720342.898	JP	1200	1200	7.374	D	3.44	750	3.979	750	3.929	JUNCTION PIT IN ROAD RESERVE. REFER TO IDM SD 420.
1/C	752144.201	5720347.727	JP	1050	900	7.232	D	3.19	750	4.088	750	4.038	JUNCTION PIT IN ROAD RESERVE. REFER TO IDM SD 420.
1/D	752163.547	5720355.198	GEP	1050	900	6.390	D	2.23	750	4.208	750	4.158	PIT TO BE HAUNCHED WITH 600X900 ACCESS. CLASS D GRATE. REFER TO IDM SD 410
1/E	752186.705	5720368.019	GEP	1050	900	5.681	D	1.39	750	4.346	750	4.296	PIT TO BE HAUNCHED WITH 600X900 ACCESS. CLASS D GRATE. REFER TO IDM SD 410
1/F	752209.636	5720373.136	GEP	1050	900	5.478	D	1.01	750	4.513	750	4.463	PIT TO BE HAUNCHED WITH 600X900 ACCESS. CLASS D GRATE. REFER TO IDM SD 410
1/G	752226.968	5720371.463	GEP	1050	900	5.770	D	1.17			750	4.601	GRILLED INLET PIT. REFER TO PIT DETAIL 1/G.
4/A	752290.370	5720487.335	EW	500	150	21.947		0.48	225	21.471			CONCRETE ENDWALL FOR PIPES UP TO 300mmØ. REFER TO IDM SD 470.
4/B	752285.156	5720488.815	JP	600	600	22.960	D	1.38	225	22.547	225	21.579	JUNCTION PIT IN ROAD RESERVE. REFER TO IDM SD 420.
4/C	752279.455	5720489.961	JP	900	600	25.146	В	1.15	225	24.501	225	24.001	JUNCTION PIT WITH NON-CONCRETE COVER (NON-TRAFFICABLE AREA). REFER TO IDM SD 426.
4/D	752251.808	5720478.347	GEP	600	600	25.688	В	0.99	225	24.751	225	24.701	JUNCTION PIT WITH NON-CONCRETE COVER (NON-TRAFFICABLE AREA). REFER TO IDM SD 426.
4/E	752222.688	5720466.115	JP	900	600	27.471	В	1.14			225	26.330	JUNCTION PIT WITH NON-CONCRETE COVER (NON-TRAFFICABLE AREA). REFER TO IDM SD 426.
5/A	752284.185	5720284.670	EW	600	600	3.662		0.49	450	3.175			REINFORCED CONCRETE WINGWALL. REFER TO IDM SD 465.
5/B	752292.266	5720313.517	GEP	1200	900	4.391	D	1.07	450	3.375	450	3.325	DEMOLISH EXISTING PIT AND FORM HAUNCHED GRATED PIT. REFER TO PIT DETAIL 5/B.
5/C	752308.855	5720324.340	GEP	900	600	4.127	D	0.65	450	3.524	450	3.474	DEPRESSED GRATED PIT. REFER TO IDM SD 455.
5/D	752333.610	5720340.610	GEP	900	600	4.490	D	0.82	450	3.722	450	3.672	DEPRESSED GRATED PIT. REFER TO IDM SD 455.
5/E	752348.334	5720348.183	JP	900	900	5.522	D	1.14	450	4.434	450	4.384	DEPRESSED GRATED PIT. REFER TO IDM SD 455.
5/F	752385.819	5720367.462	GEP	900	600	5.600	D	0.70	375	4.946	450	4.896	DEPRESSED GRATED PIT. REFER TO IDM SD 455.
5/G	752402.202	5720376.767	GSEP	900	600	7.603	D	1.20	375	6.449	375	6.399	GRATED PIT FOR SM2 MODIFIED KERB & CHANNEL. REFER TO IDM SD 480.
5/H	752407.629	5720380.950	GEP	600	600	7.650	D	1.13	300	6.568	375	6.518	DEPRESSED GRATED PIT. REFER TO IDM SD 455.
5/I	752414.123	5720375.880	GEP	600	600	7.281	D	0.63			300	6.650	GRATED PIT. REFER TO IDM SD 405.
6/A	752173.973	5720534.995	GSEP	900	600	30.210	В	0.30	225	29.910	300	29.910	300mm TALL LETTER BOX OPENING. REFER TO PIT DETAIL 6/A.
6/B	752187.580	5720540.740	JP	600	600	32.660	В	0.92	225	32.245	225	31.745	JUNCTION PIT WITH NON-CONCRETE COVER (NON-TRAFFICABLE AREA). REFER TO IDM SD 426.
6/C	752202.428	5720544.738	JP	900	600	36.092	В	0.54	225	35.600	225	35.550	JUNCTION PIT WITH NON-CONCRETE COVER (NON-TRAFFICABLE AREA). REFER TO IDM SD 426.
6/D	752216.751	5720551.600	JP	600	600	38.678	В	0.58			225	38.101	JUNCTION PIT WITH NON-CONCRETE COVER (NON-TRAFFICABLE AREA). REFER TO IDM SD 426.

- 1. ALL PITS ARE TO BE TO IDM STANDARDS UNLESS NOTED OTHERWISE.
- 2. PITS DEEPER THAN 1.00m SHALL BE FITTED WITH STEPIRONS, FIRST STEPIRON TO BE 300mm FROM THE BOTTOM OF THE PIT.
- 3. COVER LEVELS TO BE SET TO MATCH THE FINISHED SURFACE PROFILES AND ADJACENT CONSTRUCTION.
- 4. GP = GRATED PIT, GSEP = SIDE ENTRY PIT GRATED, DGSEP = DOUBLE SIDE ENTRY PIT GRATED, SEP = SIDE ENTRY PIT, DSEP = DOUBLE SIDE ENTRY PIT, JP = JUNCTION PIT, EP = END OF PIPE,
- EW = ENDWALL, DEW = DRIVEABLE ENDWALL.
- 5. UNLESS OTHERWISE SPECIFIED, PIT TYPES REFER TO IDM STANDARD DRAWINGS FIGURE SD 405 UNHAUNCHED PITS (450Ø MAX. PIPE)
 - FIGURE SD 410 HAUNCHED PITS (MIN 525Ø PIPE)
 - FIGURE SD 420 JUNCTION PIT IN ROAD RESERVE
 - FIGURE SD 426 JUNCTION PIT WITH NON-CONCRETE COVER (NON TRAFFICABLE AREAS)
 - FIGURE SD 441 GRATED SIDE ENTRY PIT WITH LIGHTWEIGHT COVER & CONCRETE SURROUND FOR 'SM2-M'
 - FIGURE SD 455 DEPRESSED GRATED PIT
 - FIGURE SD 460 INLET CATCH PIT
 - FIGURE SD 465 REINFORCED CONCRETE WINGWALL (IN-SITU)
 - FIGURE SD 470 CONCRETE ENDWALL FOR PIPES UP TO 300mmØ (WALKWAYS, PATHS AND TRACKS) FIGURE SD 480 GRATED PIT FOR SM2 MODIFIED KERB & CHANNEL
 - FIGURE SD 481 ALTERNATE GRATED PIT FOR SM2 MODIFIED KERB & CHANNEL 'SM2-M' UPSTREAM PIT ONLY
- FIGURE SD 496 MODIFIED EXISTING PIT TO GRATED PIT IN VEHICLE CROSSING / LAYBACK 6. FOR HAUNCHED PITS REFER TO IDM STANDARD DRAWING FIGURE SD 410. PITS TO BE HAUNCHED TO COUNCIL STANDARD OPENINGS.
- STUBS AND PIPE ENDS TO BE BLOCKED OFF TO COUNCIL'S SATISFACTION.
- ALL GRATED PITS TO HAVE BICYCLE SAFE LOCKDOWN GRATES.
- 9. ALL GRATED SIDE-ENTRY PITS TO HAVE MIN 100mm THICK CONCRETE APRON BETWEEN GRATE AND ASPHALT. REFER IDM STANDARD DRAWINGS.
- 10. PITS WITHIN ROAD PAVEMENT, VEHICLE CROSSINGS OR WITHIN 0.75m OF A VEHICLE CROSSING, TO HAVE CLASS D CAST IRON LOCK DOWN LIDS, LID INFILL COLOURED TO MATCH ROAD
- 11. ALL PITS WITHIN ROAD TO BE CONSTRUCTED WITH 32 MPa CONCRETE WITH SL92 MESH IN WALLS AND BASE.
- 12. CONTRACTOR TO VERIFY EXISTING SERVICES CONNECTION LEVELS PRIOR TO CONSTRUCTION. ANY DISCREPANCIES MUST BE IMMEDIATELY IDENTIFIED AND THE SUPERINTENDENT NOTIFIED

25/10/2017 FOR TENDER E.H E.H 18/10/2017 FOR TENDER J.O E.H Date Description Des. Verif. Appd.

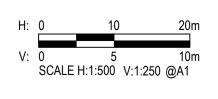

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	J.O	18/10/2017
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	E.H	18/10/2017
	Designed	Date
	J.O	18/10/2017
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	Approved	Date

COLAC OTWAY SHIRE Project WYE RIVER AND SEPARATION CREEK STORMWATER MANAGEMENT SYSTEM DETAILED DESIGN PITS AND PIPES Title SEPARATION CREEK

DRAINAGE PIT SCHEDULE

FOR TENDER ONLY NOT TO BE USED FOR CONSTRUCTION PURPOSES A.H.D X927,C9 AS SHOWN A1 V170115-CI-3210

